

VICINITY MAP

ISSUE LOG

No.	DATE ISSUED:	ISSUE DESCRIPTION





TEXAS BOARD OF PROFESSIONAL ENGINEERS F-19379 4611 BIGGAM DRIVE FRESNO, TEXAS 77545 (832) 443-4150


PROPOSED COFFEE HOUSE 1500 NEWTON STEET BRYAN, TEXAS 77803

VICINITY MAP

DESIGNED BY : G.W. DRAWN BY : M.B. CHECKED BY : APPROVED BY : DATE: AUG. 15, 200 SCALE: N.T.S. PROJECT NO:

SHEET

C0.01

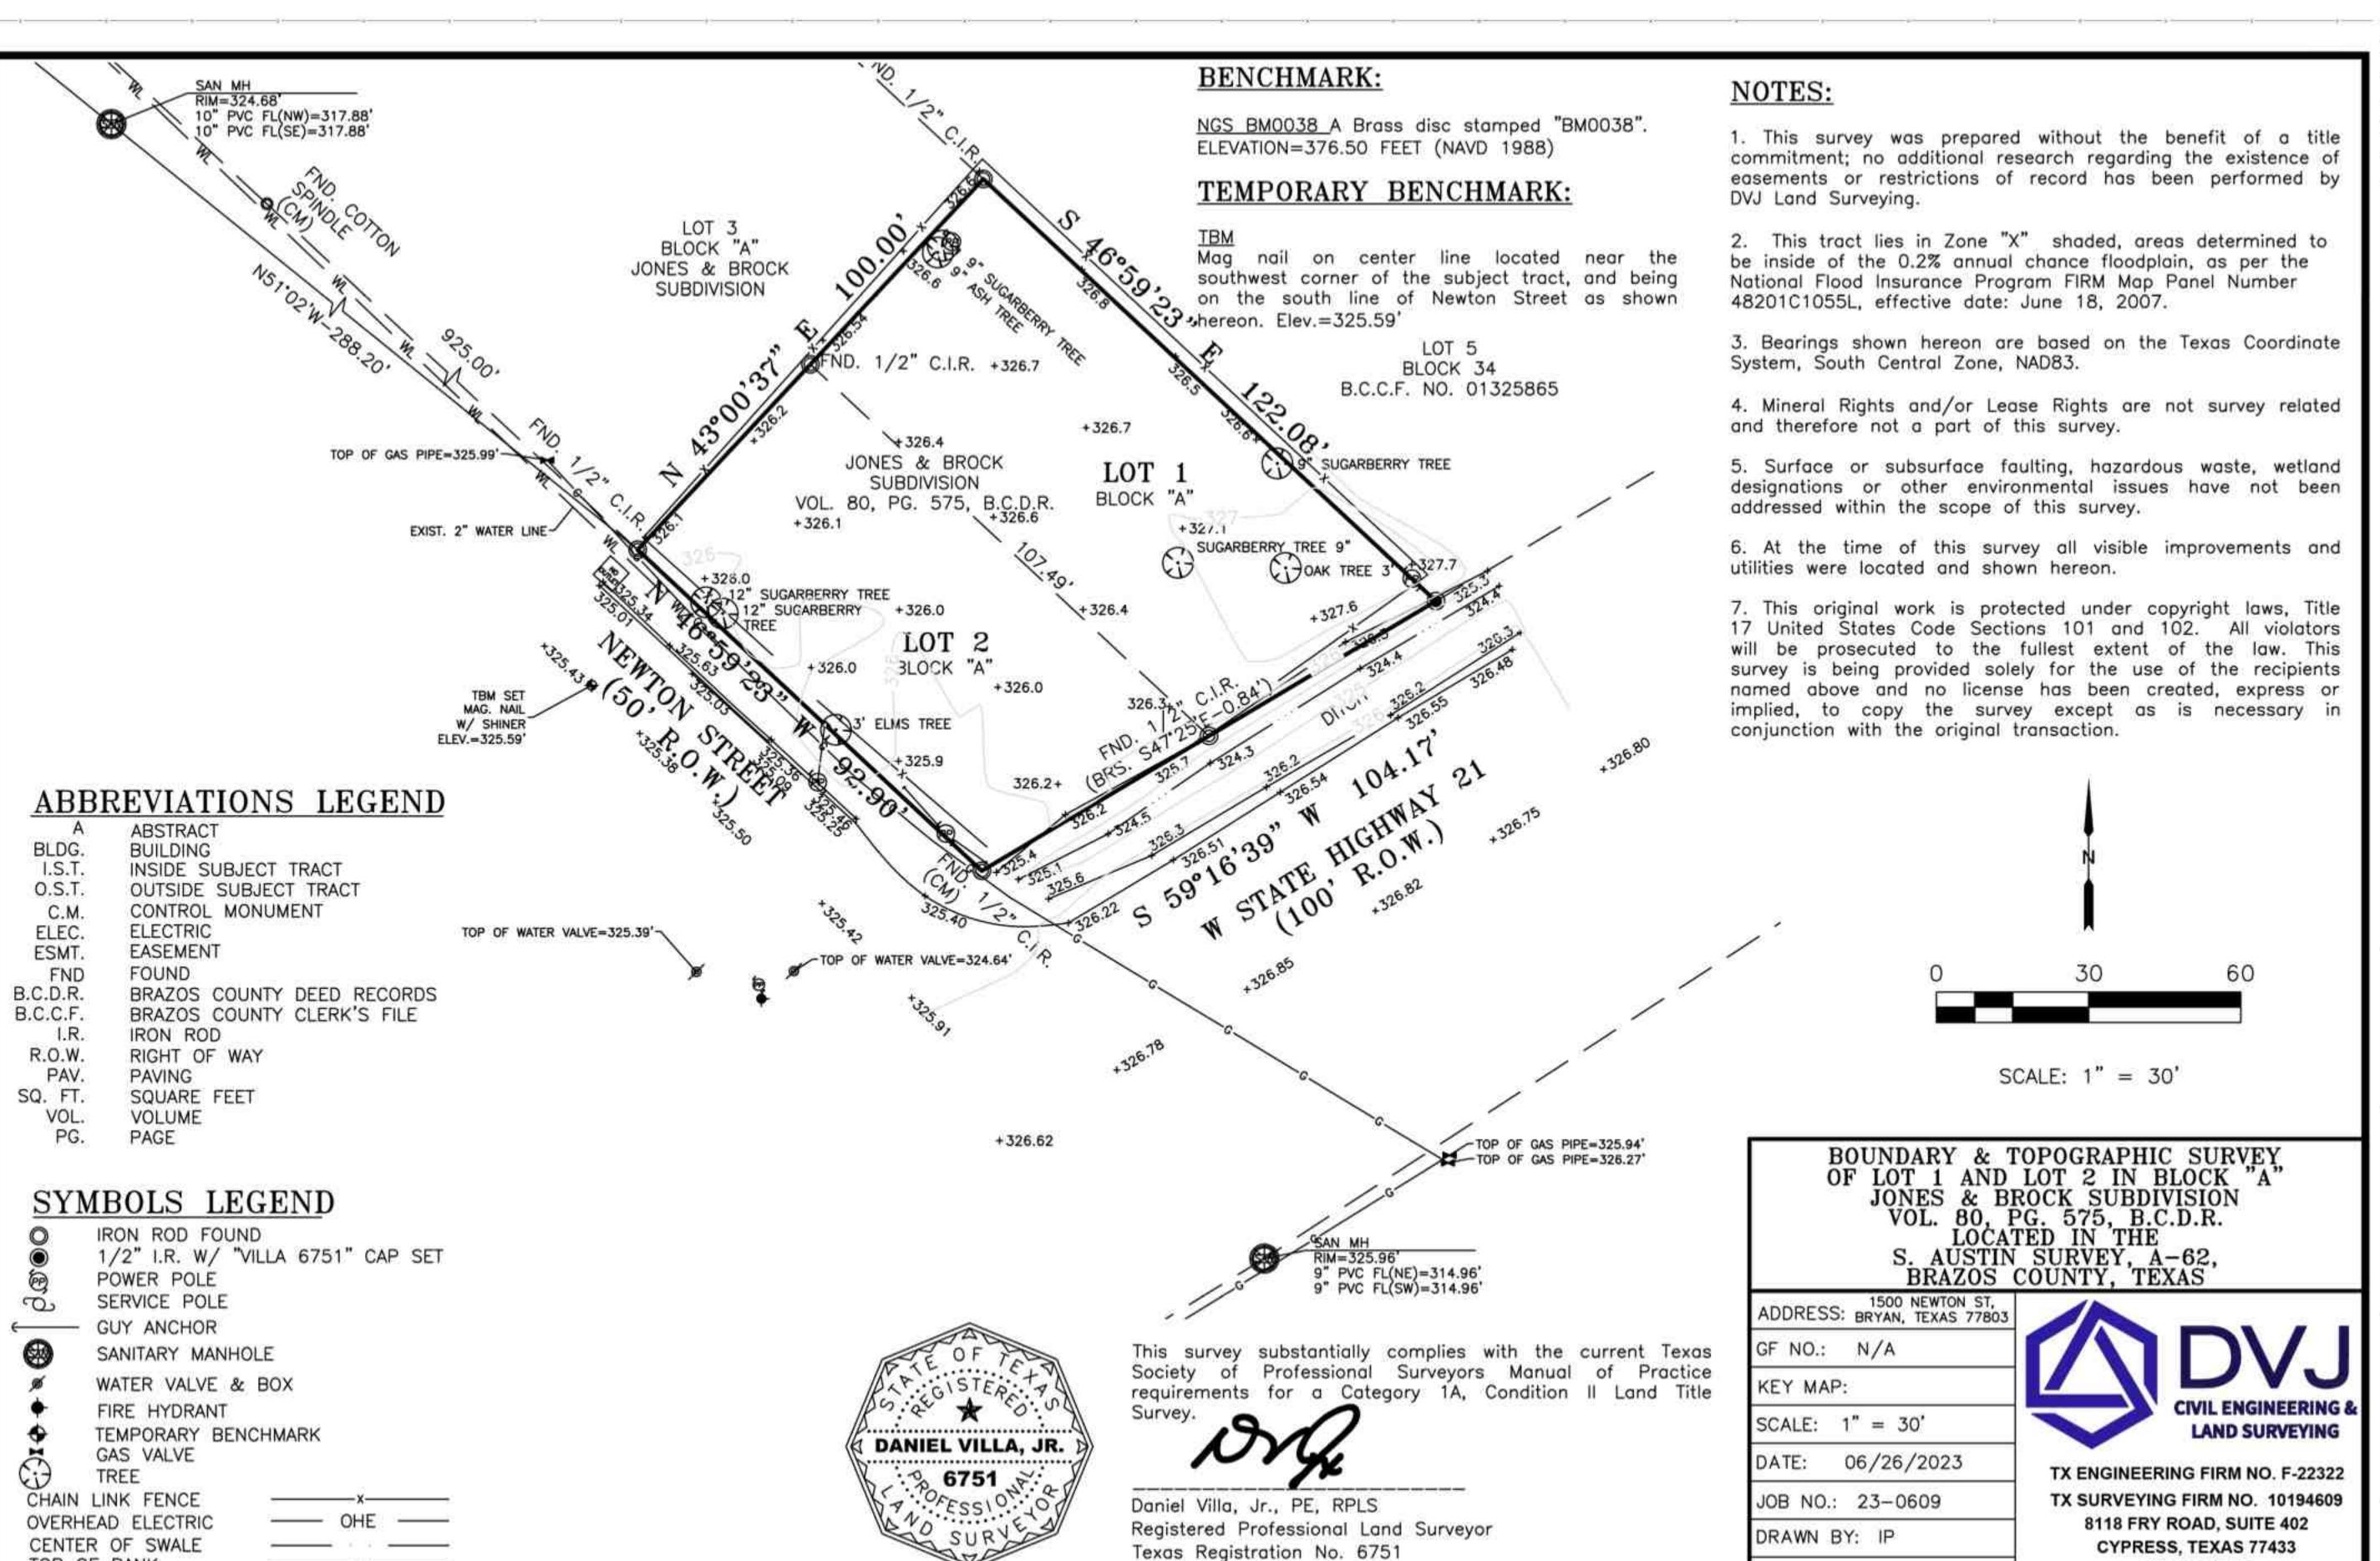

TOP OF BANK

ISSUE DESCRIPTION

ISSUE LOG





TEXAS BOARD OF PROFESSIONAL ENGINEERS F-19379 4611 BIGGAM DRIVE FRESNO, TEXAS 77545 (832) 443-4150

PROPOSED COFFEE HOUSE 1500 NEWTON STEET BRYAN, TEXAS 77803

TOPOGRAPHIC SURVEY


DRAWN BY : CHECKED BY APPROVED BY :

281.213.2517

CHECKED BY: C.E.G.

DATE: AUG. 15, 2023 SCALE : N.T.S. PROJECT NO :

C1.00

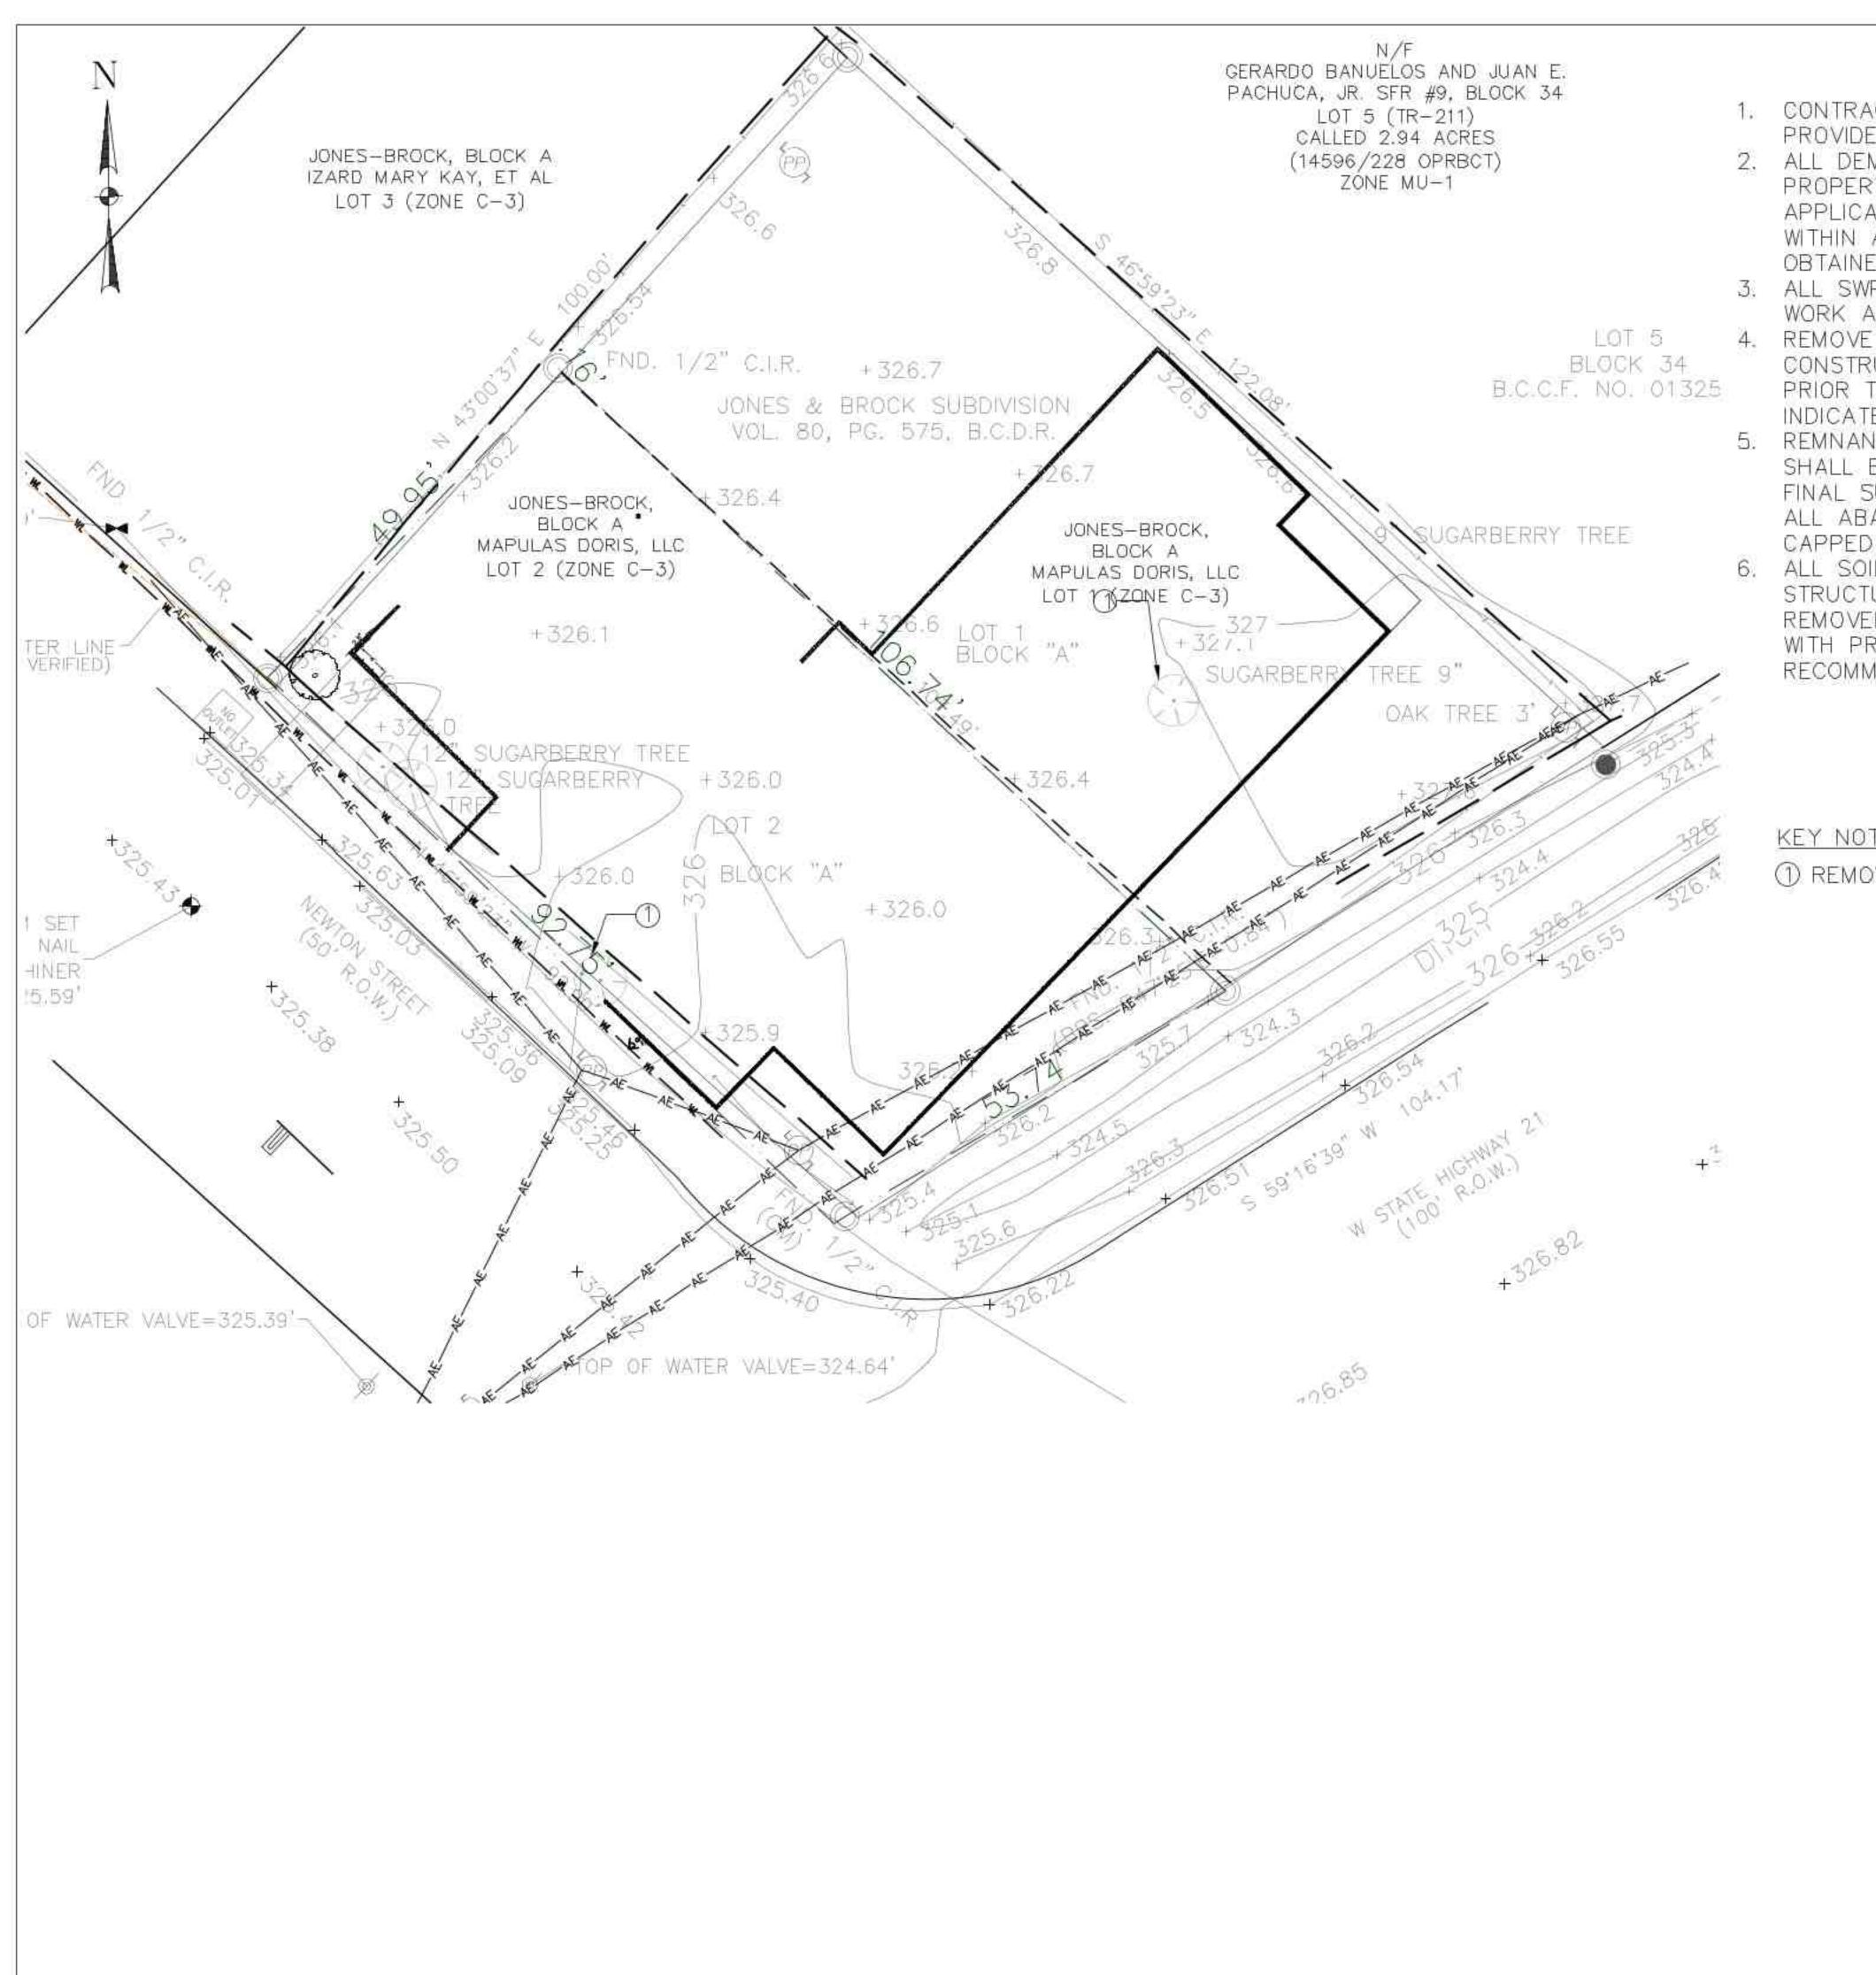

1. CONTRACTOR SHALL SECURE ALL REQUIRED PERMITS AND PROVIDE ALL REQUIRED NOTIFICATIONS PRIOR TO WORK.

2. ALL DEMOLITION WORK TO BE PERFORMED WITHIN PROJECT PROPERTY LINES UNLESS AUTHORIZED OTHERWISE BY APPLICABLE PROPERTY OWNER. NO WORK TO BE PERFORMED WITHIN ADJACENT STREET ROW UNTIL APPLICABLE PERMITS OBTAINED AND NOTIFICATIONS ARE PROVIDED.

3. ALL SWPPP CONTROLS TO BE INSTALLED PRIOR TO DEMOLITION WORK AS APPLICABLE, RE: SHT C7.00 & C8.01.

4. REMOVE ALL ITEMS AS REQUIRED TO FACILITATE PROPOSED CONSTRUCTION, NOTIFY ENGINEER AND OBTAIN APPROVAL PRIOR TO WORK FOR REMOVAL OF ANY ITEMS FOUND NOT INDICATED ON THIS PLAN.

5. REMNANTS OF BURIED STRUCTURES OR ABANDONED UTILITIES SHALL BE REMOVED TO A MINIMUM OF 24 INCHES BELOW FINAL SUBGRADE ELEVATION UNLESS INDICATED OTHERWISE. ALL ABANDONED UTILITIES AUTHORIZED TO REMAIN SHALL BE CAPPED WATERTIGHT.

6. ALL SOILS DISTURBED DURING THE DEMOLITION OF STRUCTURES, TREES, OR UNDERGROUND UTILITIES SHALL BE REMOVED OR REPLACED AND COMPACTED IN ACCORDANCE WITH PROJECT SPECIFICATIONS AND GEOTECHNICAL REPORT RECOMMENDATIONS.

KEY NOTES:

(1) REMOVE AND DISPOSE EXIST. TREE.

ISSUE LOG

No.	DATE ISSUED:	ISSUE DESCRIPTION
	9.0	
-		
	1	





TEXAS BOARD OF PROFESSIONAL ENGINEERS F-19379 4611 BIGGAM DRIVE FRESNO, TEXAS 77545 (832) 443-4150

PROPOSED COFFEE HOUSE 1500 NEWTON STEET BRYAN, TEXAS 77803


GRADING PLAN


CHECKED BY APPROVED BY

SCALE : 1" = 10'-0" PROJECT NO :

SHEET

C2.00

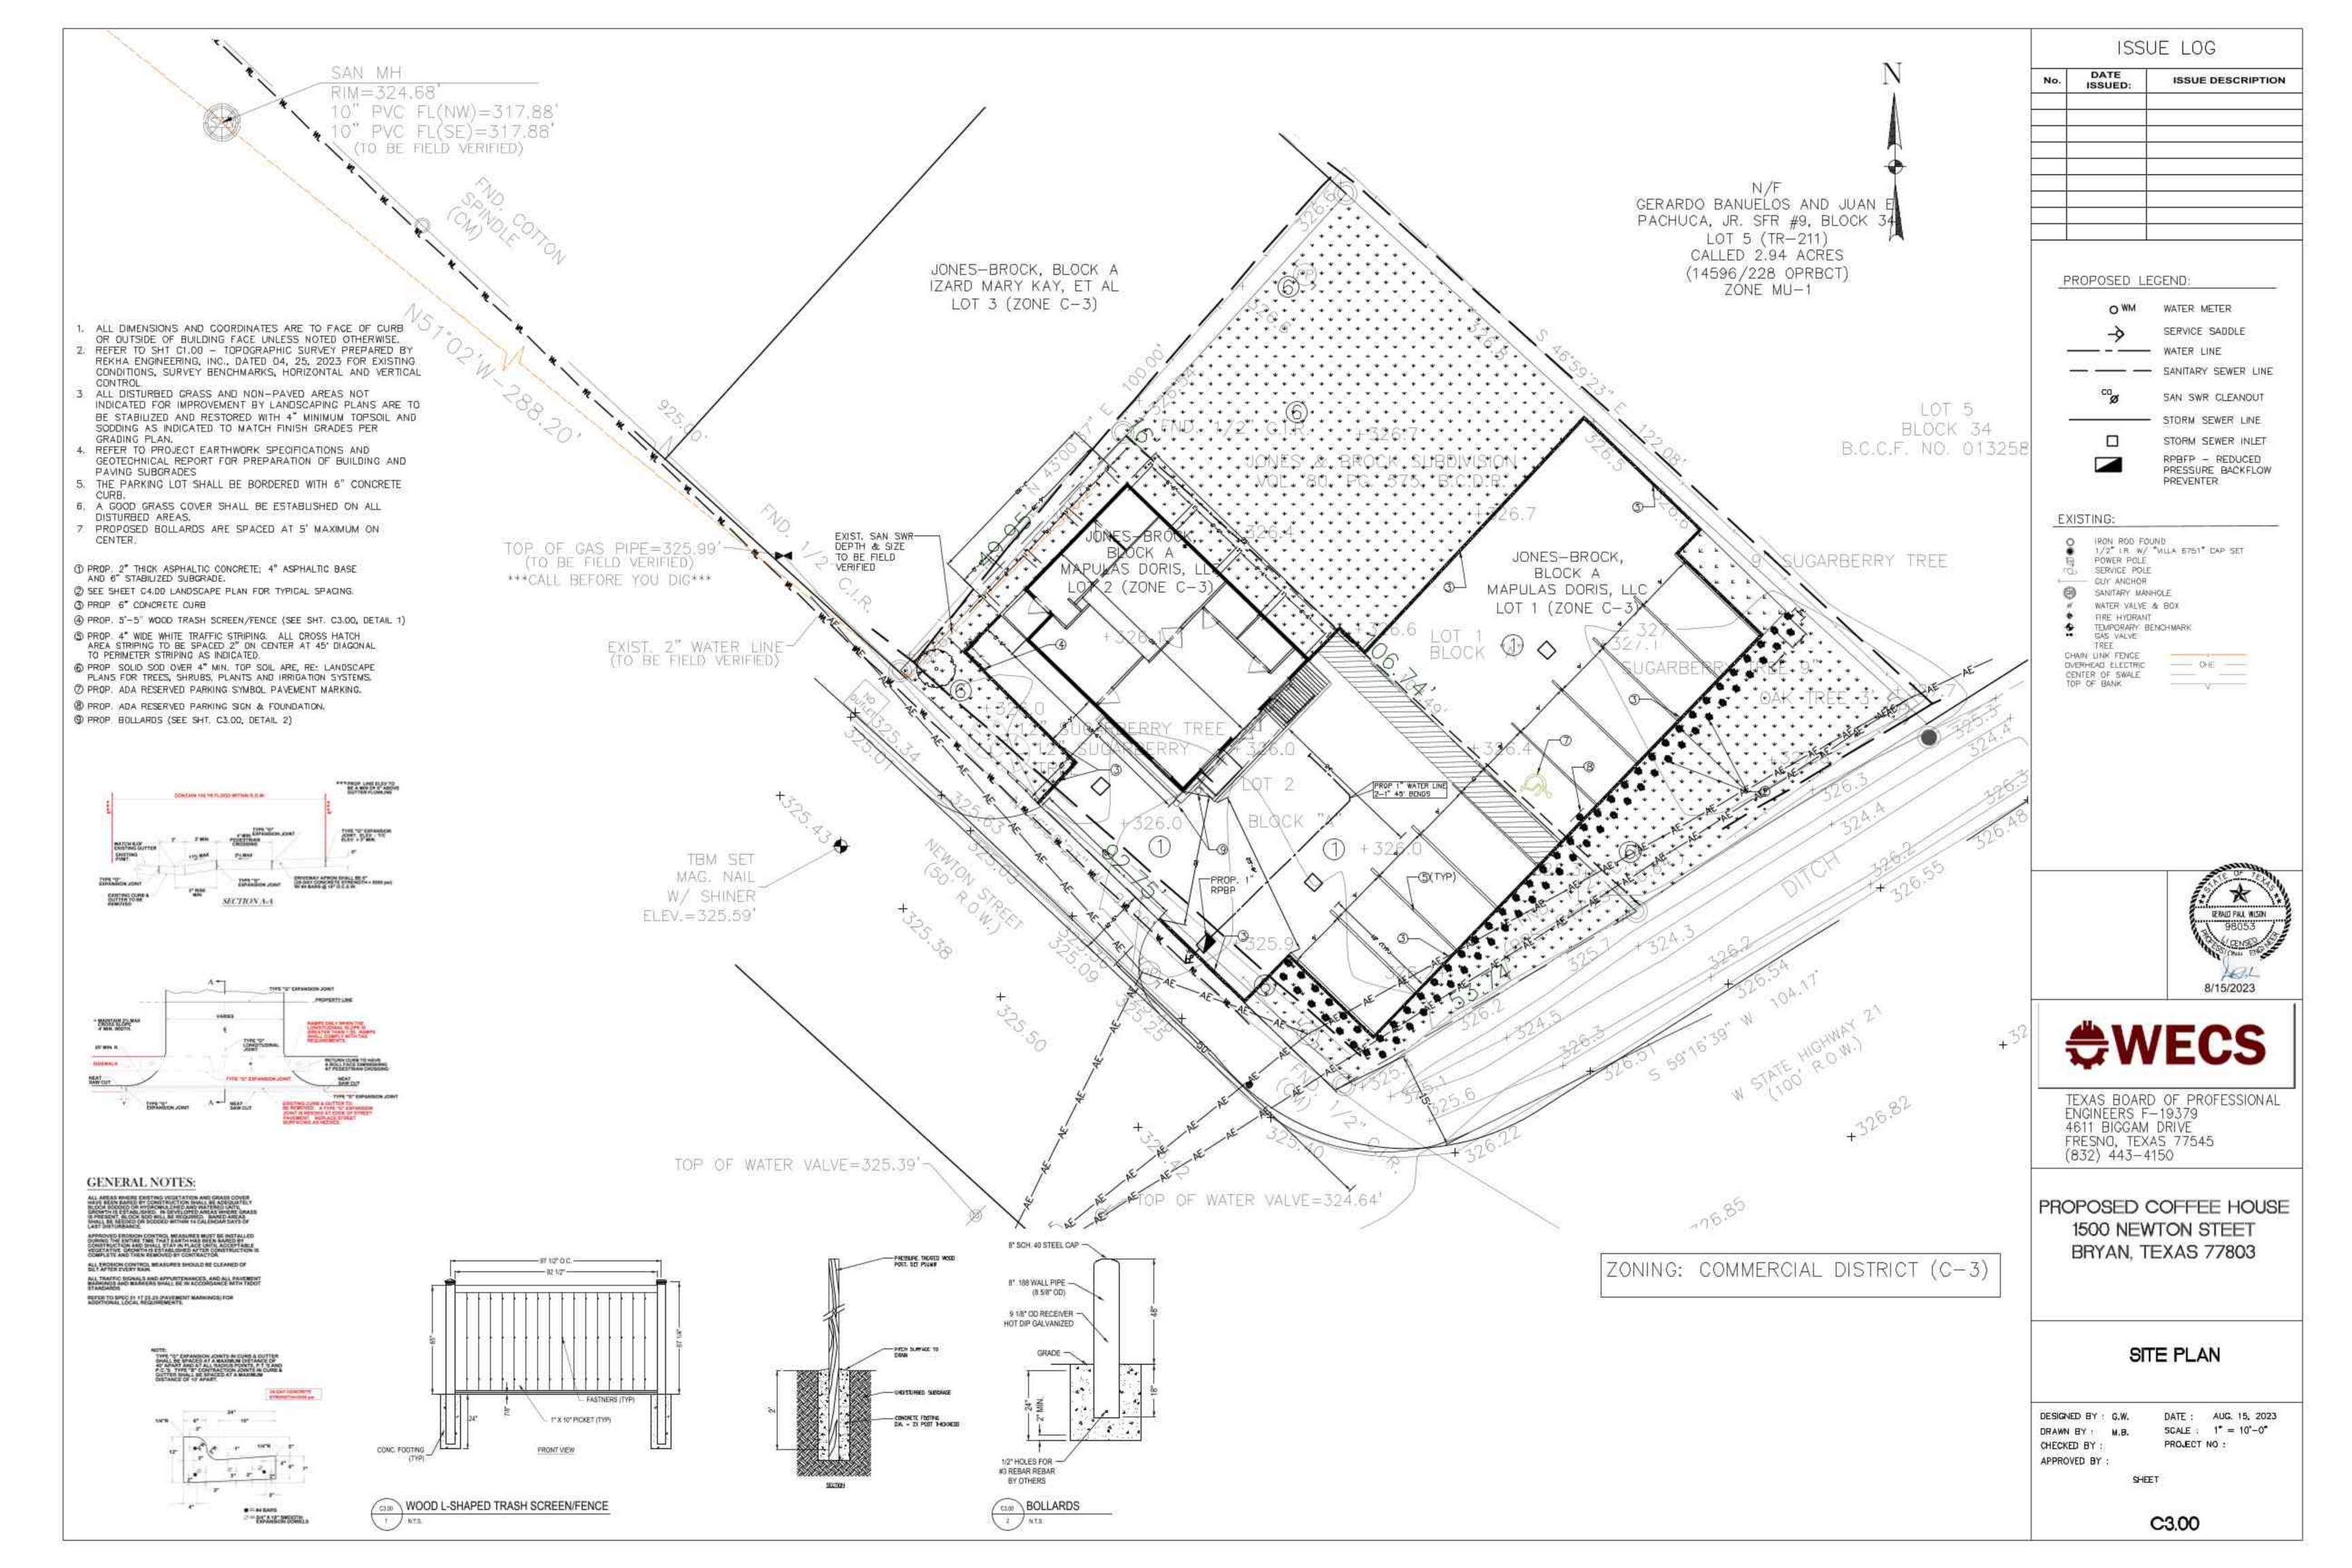

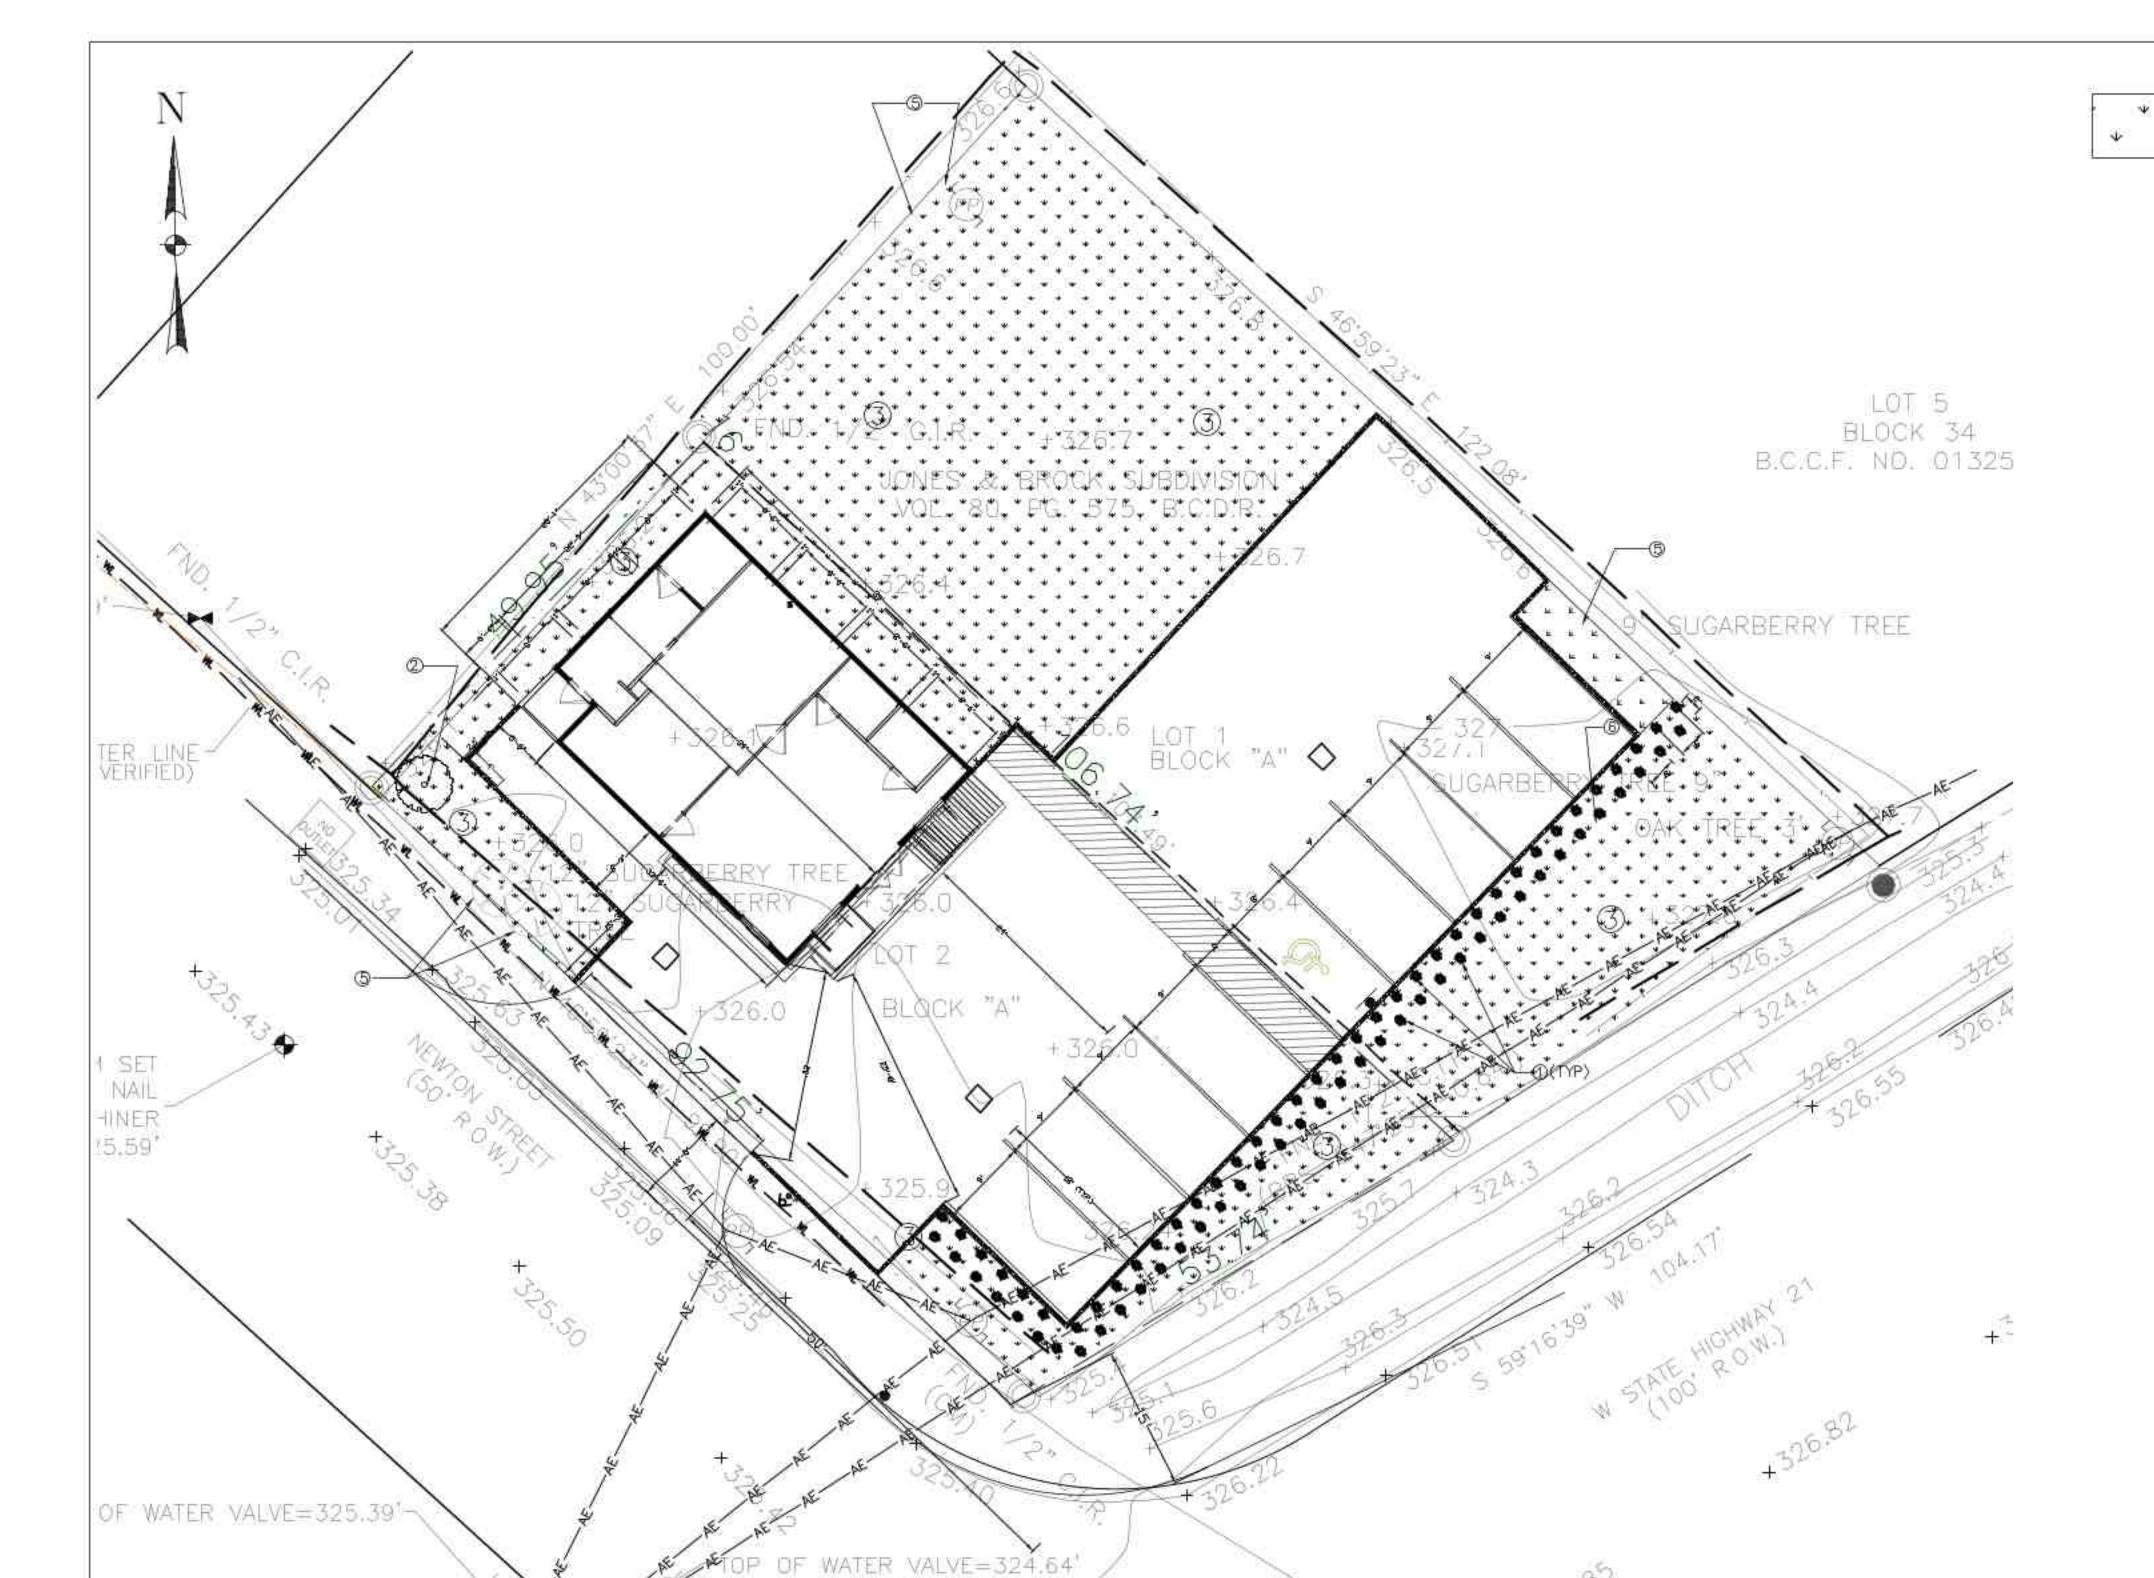

ISSUE LOG

PROP. SODDING/LANDSCAPE

No. DATE ISSUE DESCRIPTION

98053 (PNAI PENAI PENAI



TEXAS BOARD OF PROFESSIONAL ENGINEERS F-19379 4611 BIGGAM DRIVE FRESNO, TEXAS 77545 (832) 443-4150

PROPOSED COFFEE HOUSE 1500 NEWTON STEET BRYAN, TEXAS 77803

LANDSCAPE PLAN

DESIGNED BY :

DRAWN BY :

CHECKED BY :

APPROVED BY :


SCALE: 1" = 10"-0"
PROJECT NO:

SHEET

C4.00

- ALL DIMENSIONS AND COORDINATES ARE TO FACE OF CURB OR OUTSIDE OF BUILDING FACE UNLESS NOTED OTHERWISE.
- 2. ALL DISTURBED GRASS AND NON-PAVED AREAS NOT INDICATED FOR IMPROVEMENT BY LANDSCAPING PLANS ARE TO BE STABILIZED AND RESTORED WITH 4" MINIMUM TOPSOIL AND SODDING AS INDICATED TO MATCH FINISH GRADES PER GRADING PLAN.
- 3. REFER TO PROJECT SPECIFICATIONS FOR ALL MINIMUM AND ADDITIONAL REQUIREMENTS.
- 4. A GOOD GRASS COVER SHALL BE ESTABLISHED ON ALL DISTURBED AREAS.

- ① PROP. SHRUB
- PROP. WATER OAK TREE
- 3 PROP. SODDING
- SEE SHEET C4.01 LANDSCAPE PLAN FOR TYPICAL SHRUB SPACING,
- 5 EXIST, SUGARBERRY TREE
- 6 EXIST, OAK TREE

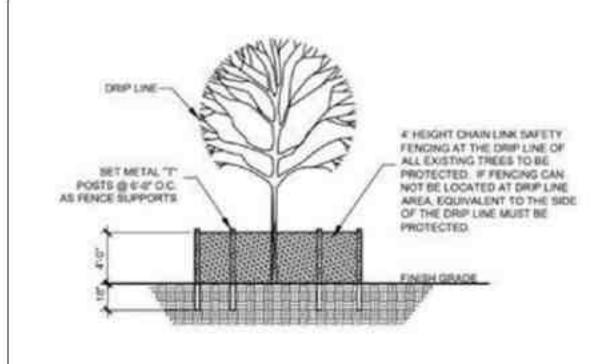


F TREE PROTECTION DETAIL

TREE PROTECTION NOTES

- 1. EXISTING TREES SHOWN TO REMAIN ARE TO BE PROTECTED. DURING CONSTRUCTION. CHAINLINK FENCING (MIN. 4'4") HEIGHT) SHALL BE INSTALLED AT THE DRIP LINE OF ALL TREES OR TREE GROUPS TO REMAIN. PARKING OF VEHICLES OR PERFORMING WORK WITHIN THESE AREAS OTHER THAN SHOWN ON THE PLAN, WILL NOT BE ALLOWED. THE TREE PROTECTION SHALL REMAIN DURING CONSTRUCTION: OTHER TREE PROTECTION MEASURES SHALL BE IN ACCORDANCE WITH THE CITY'S STANDARDS AND DROMANCES
- 2. DISPOSAL OF ANY WASTE MATERIAL SUCH AS: BUT NOT LIMITED TO, PAINT, ASPHALT, CIL SOLVENTS, CONCRETE. MORTAR, ETC. WITHIN THE CANOPY AREA OF THE EXISTING TREES SHALL NOT BE ALLOWED.
- 3 NO ATTACHMENTS OR WIRES OF ANY KIND, OTHER THAN THOSE OF A PROTECTIVE NATURE. SHALL BE ATTACHED TO
- 4. NO FILL OR EXCAVATION OF ANY NATURE SHALL OCCUR. WITHIN THE DRIP LINE OF A TREE TO BE PRESERVED, UNLESS THERE IS A SPECIFIED WELL OR RETAINING WALL SHOWN ON THE GRADING PLAN.
- 5. NO MATERIALS SHALL BE STORED WITHIN THE DRIPLINE AREA OF A TREE TO BE PRESERVED

NOT TO SCALE

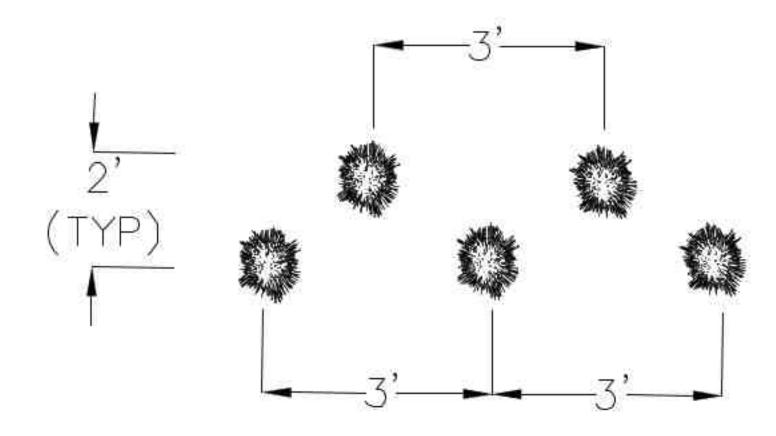

SCREENING SHRUB - DETAIL 2 SCALE: NTS

SYMBOL	SIZE	OFFICIAL NAME	No.	SF VALUE	TOTAL
	1.5" - 3" CALIPER	15 GALLON SHRUBS (3' IN HEIGHT OR TO GROW 3' IN HEIGHT)	77	15	1155
	1-3" CALIPER	PROP. WATER OAK TREE	4	200	800
		TOTAL ARE	PROVIDED	:	1,955 SF

LANDSCAPE REQUIREMENTS:

- 1) 15% OF DEVELOPED AREA 0.24 ACRES (10,578 SF) = 1,587 SF OF LANDSCAPING
- 2) NOT LESS THAN 50% OF REQUIRED AREA SHALL BE TREES 794 SF REQ'D: 800 SF PROVIDED

3) NOT LESS THAN 50% OF TREES PLANTED SHALL BE CANOPY- 397 SF REQ'D: 800 SF PROVIDED

TOTAL AREA REQUIRED: 1,587 SF TOTAL LANDSCAPE AREA PROVIDED: 1,955 SF **AUTOMATIC IRRIGATION IS REQUIRED FOR THIS PROJECT**

	ISSU	JE LOG
No.	DATE ISSUED:	ISSUE DESCRIPTION





TEXAS BOARD OF PROFESSIONAL ENGINEERS F-19379 4611 BIGGAM DRIVE FRESNO, TEXAS 77545 (832) 443-4150


PROPOSED COFFEE HOUSE 1500 NEWTON STEET BRYAN, TEXAS 77803

LANDSCAPE PLAN

CHECKED BY : APPROVED BY :

DATE: AUG. 15, 2023 SCALE : N.T.S. PROJECT NO :

C4.00

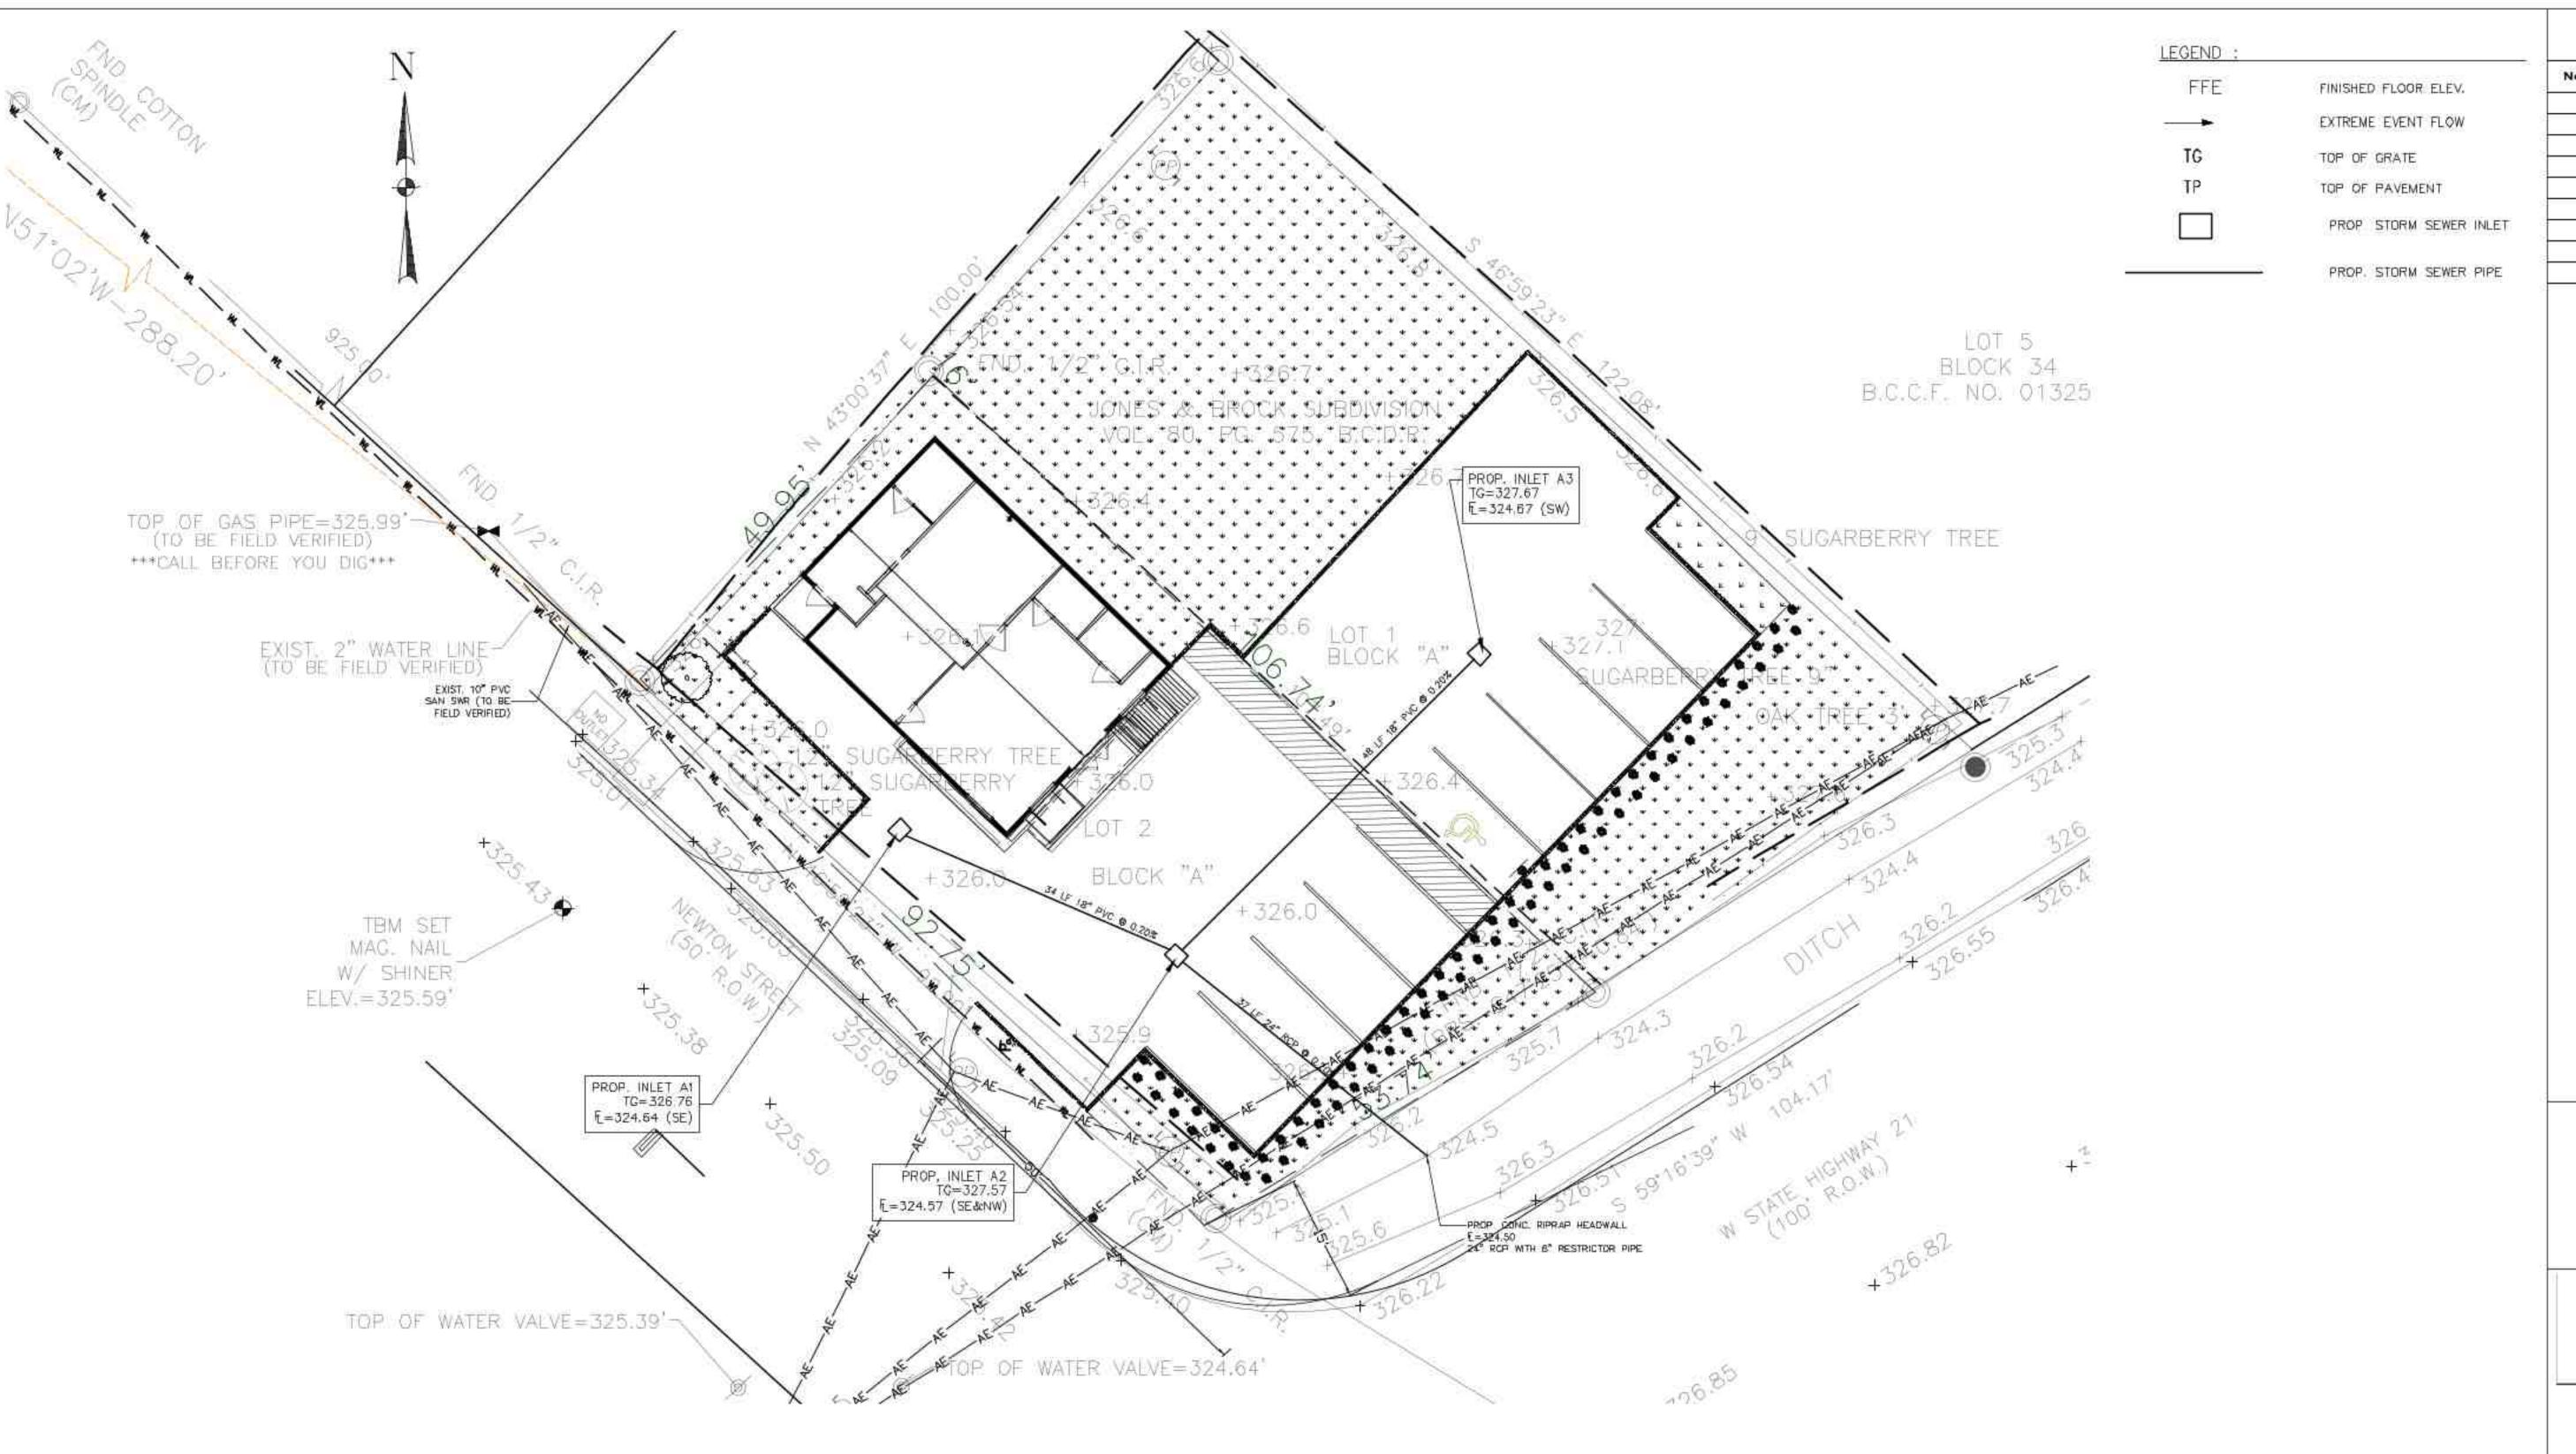

1. REFER TO SHT C8.00 - UTILITY PLAN FOR

WASTEWATER/SANITARY UTILITIES.

ERALI PAL WISHN
98053



ISSUE LOG

ISSUE DESCRIPTION

TEXAS BOARD OF PROFESSIONAL ENGINEERS F-19379 4611 BIGGAM DRIVE FRESNO, TEXAS 77545 (832) 443-4150

PROPOSED COFFEE HOUSE 1500 NEWTON STEET BRYAN, TEXAS 77803


DRAINAGE PLAN

DESIGNED BY : G.W DRAWN BY : M.E CHECKED BY : APPROVED BY :

SCALE: 1° = 10°-0°
PROJECT NO:

SHEET

C5.00

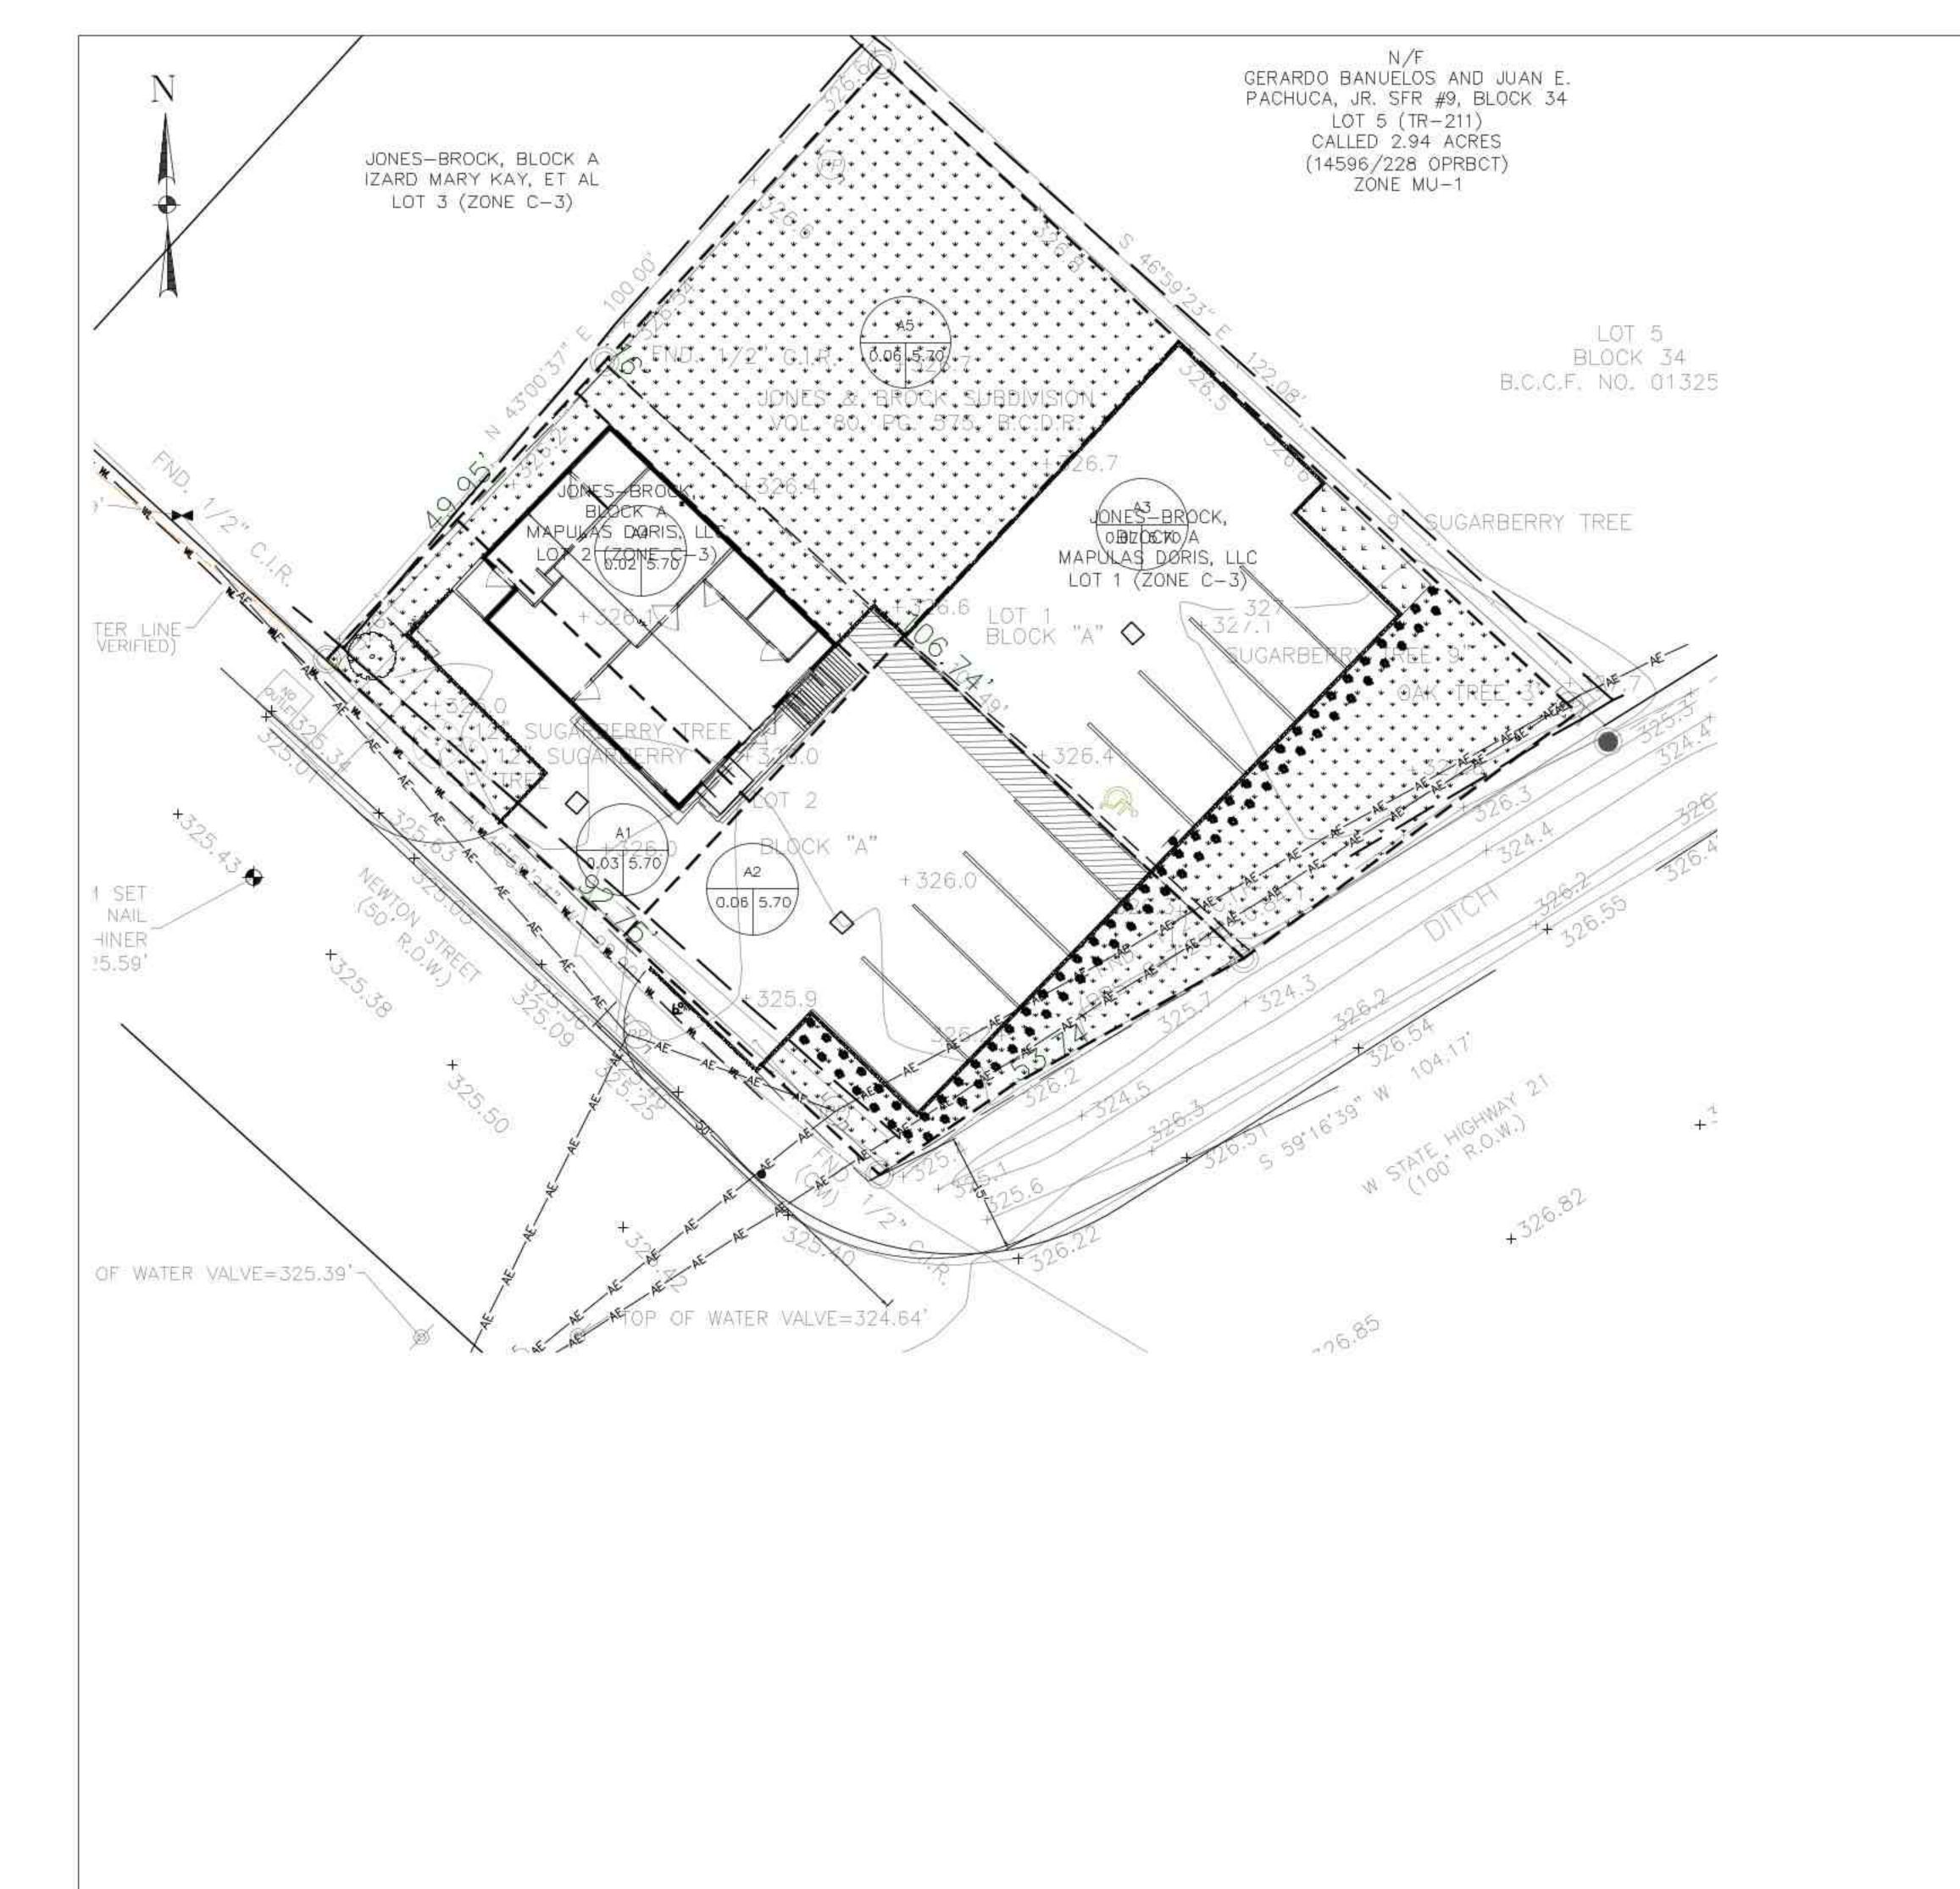

LEGEND:

AC ACRES

DA DRAINAGE AREA

FL FLOW LINE

PROP. PROPOSED

SW STORM WATER

STORM WATER

WATER METER

PROPOSED SANITARY SEWER LINE

STORM SEWER LINE WATER LINE SHEET FLOW

FOR DRAINAGE AREA ISSUE LOG

No.	DATE ISSUED:	ISSUE DESCRIPTION





TEXAS BOARD OF PROFESSIONAL ENGINEERS F-19379 4611 BIGGAM DRIVE FRESNO, TEXAS 77545 (832) 443-4150

PROPOSED COFFEE HOUSE 1500 NEWTON STEET BRYAN, TEXAS 77803

DRAINAGE AREA MAP

DESIGNED BY :

DRAWN BY :


CHECKED BY :


APPROVED BY :

SCALE : 1" = 10'-0" PROJECT NO :

SHEET

C6.00

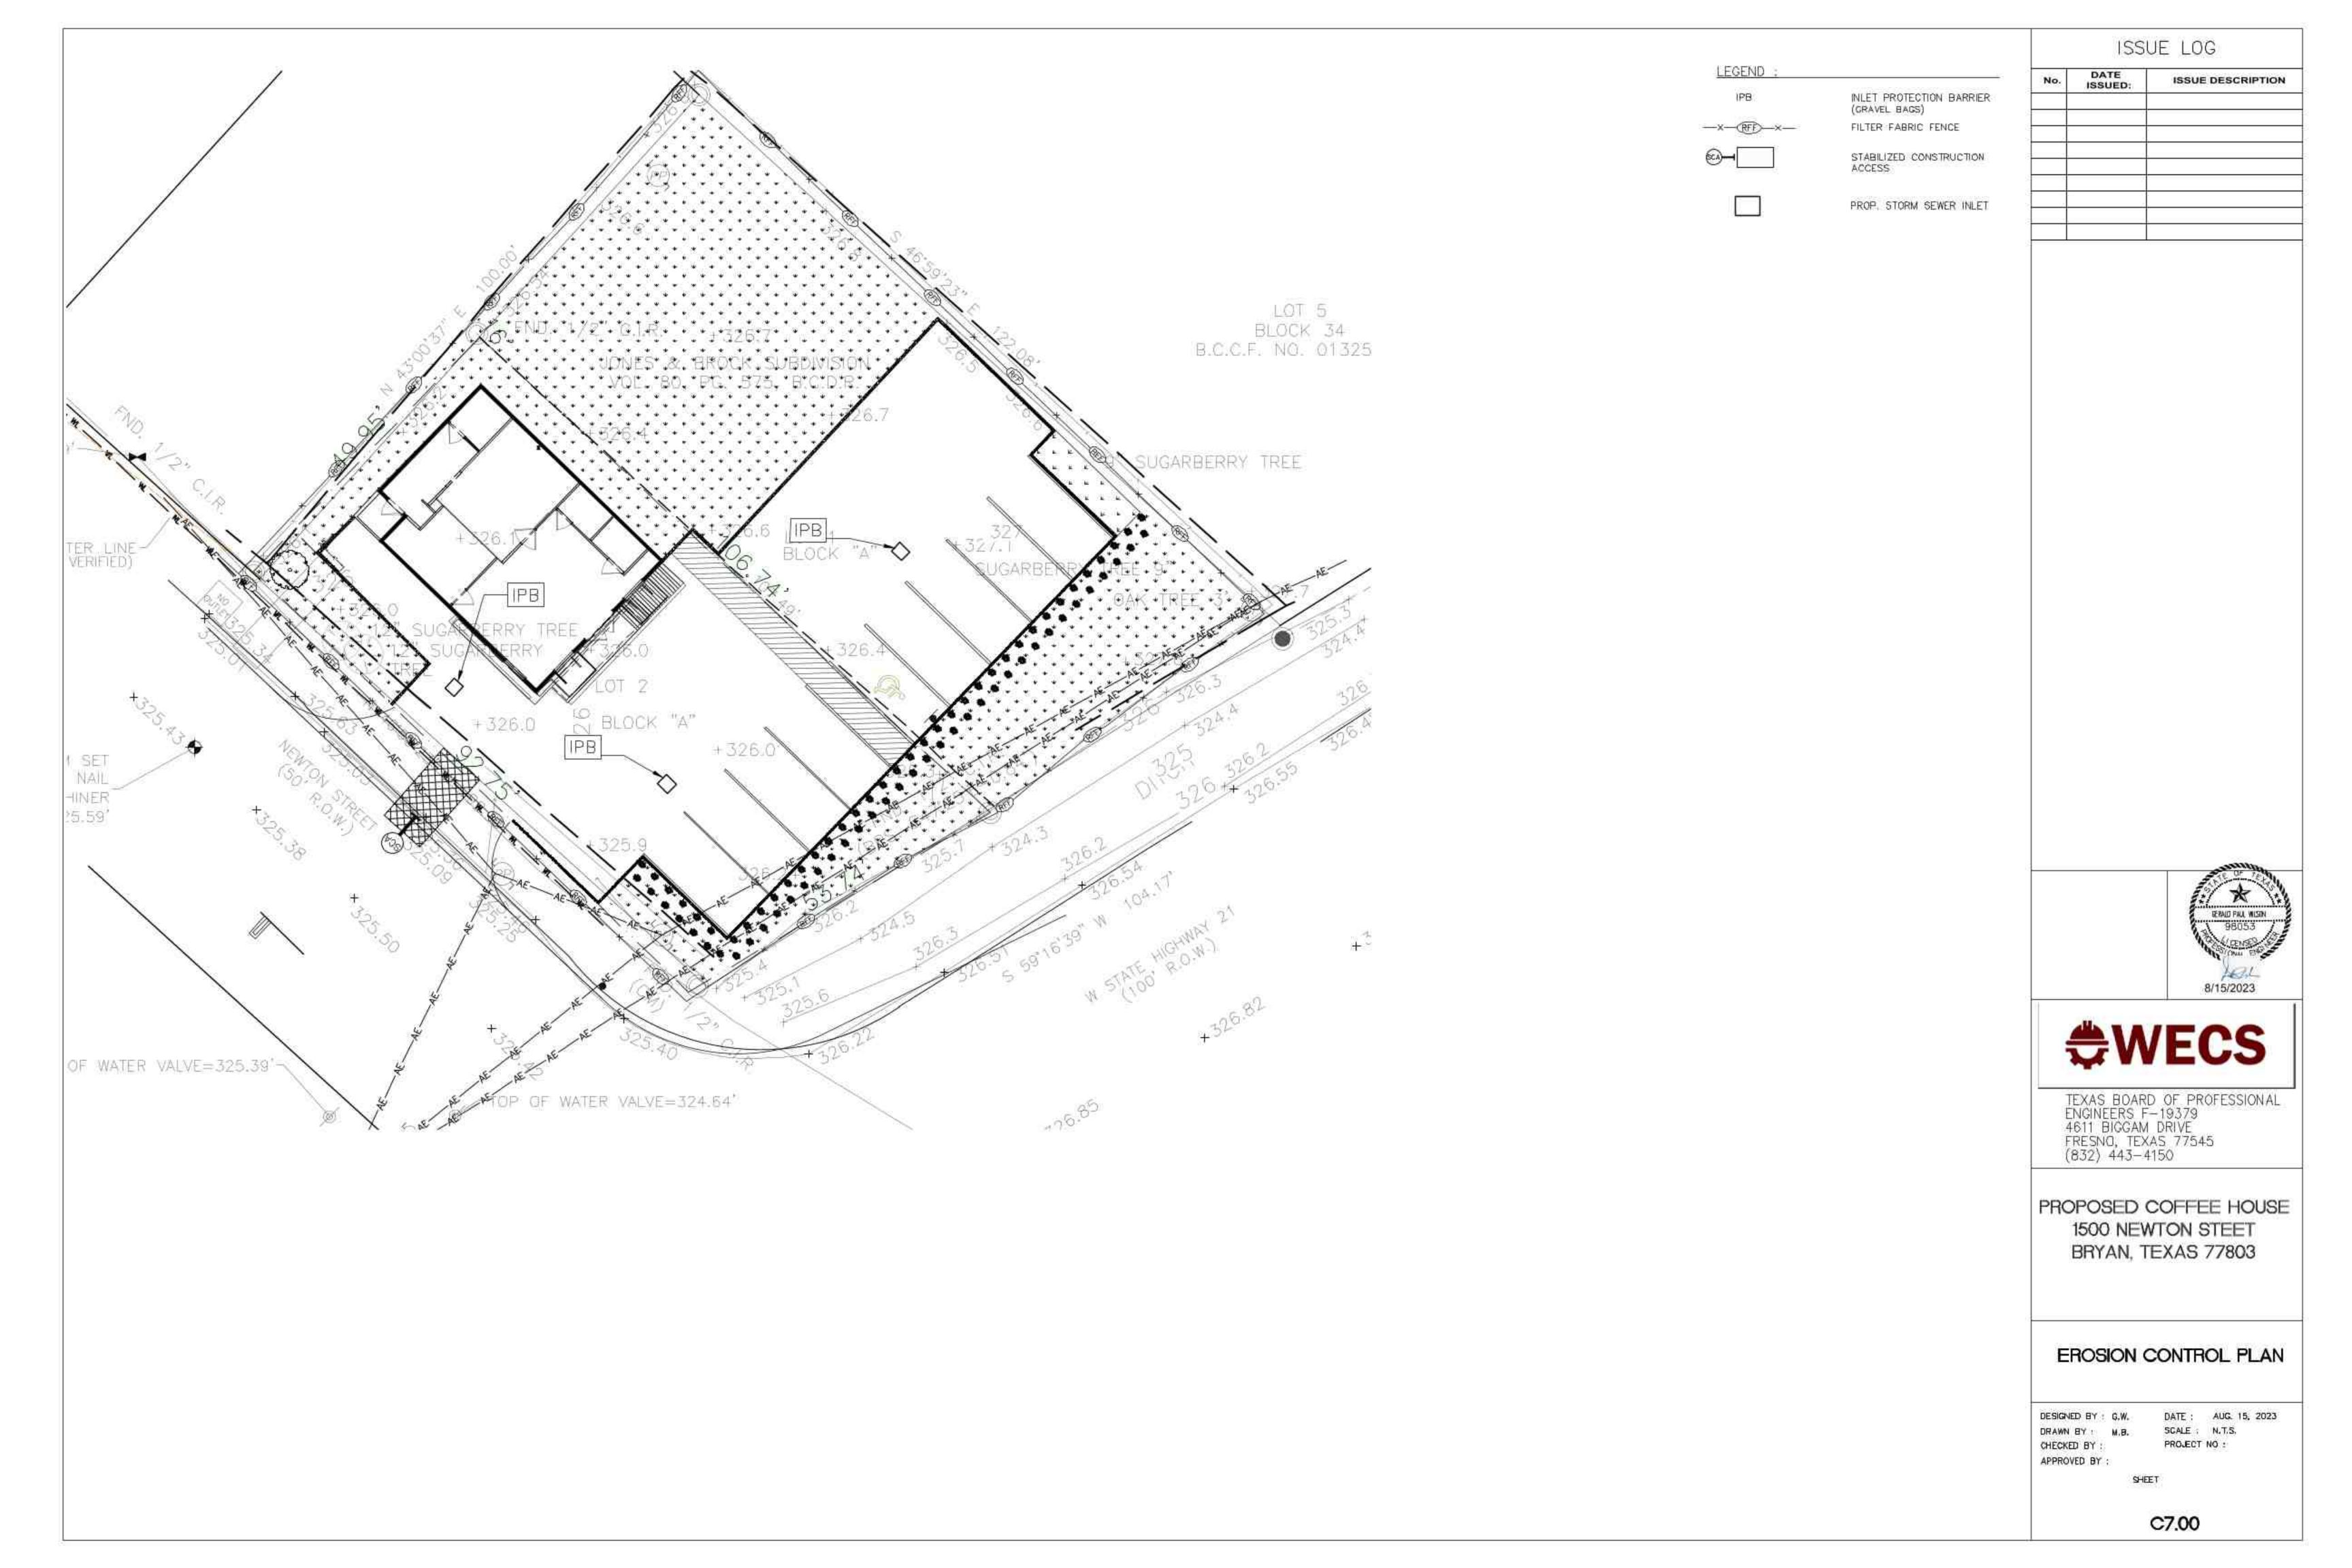

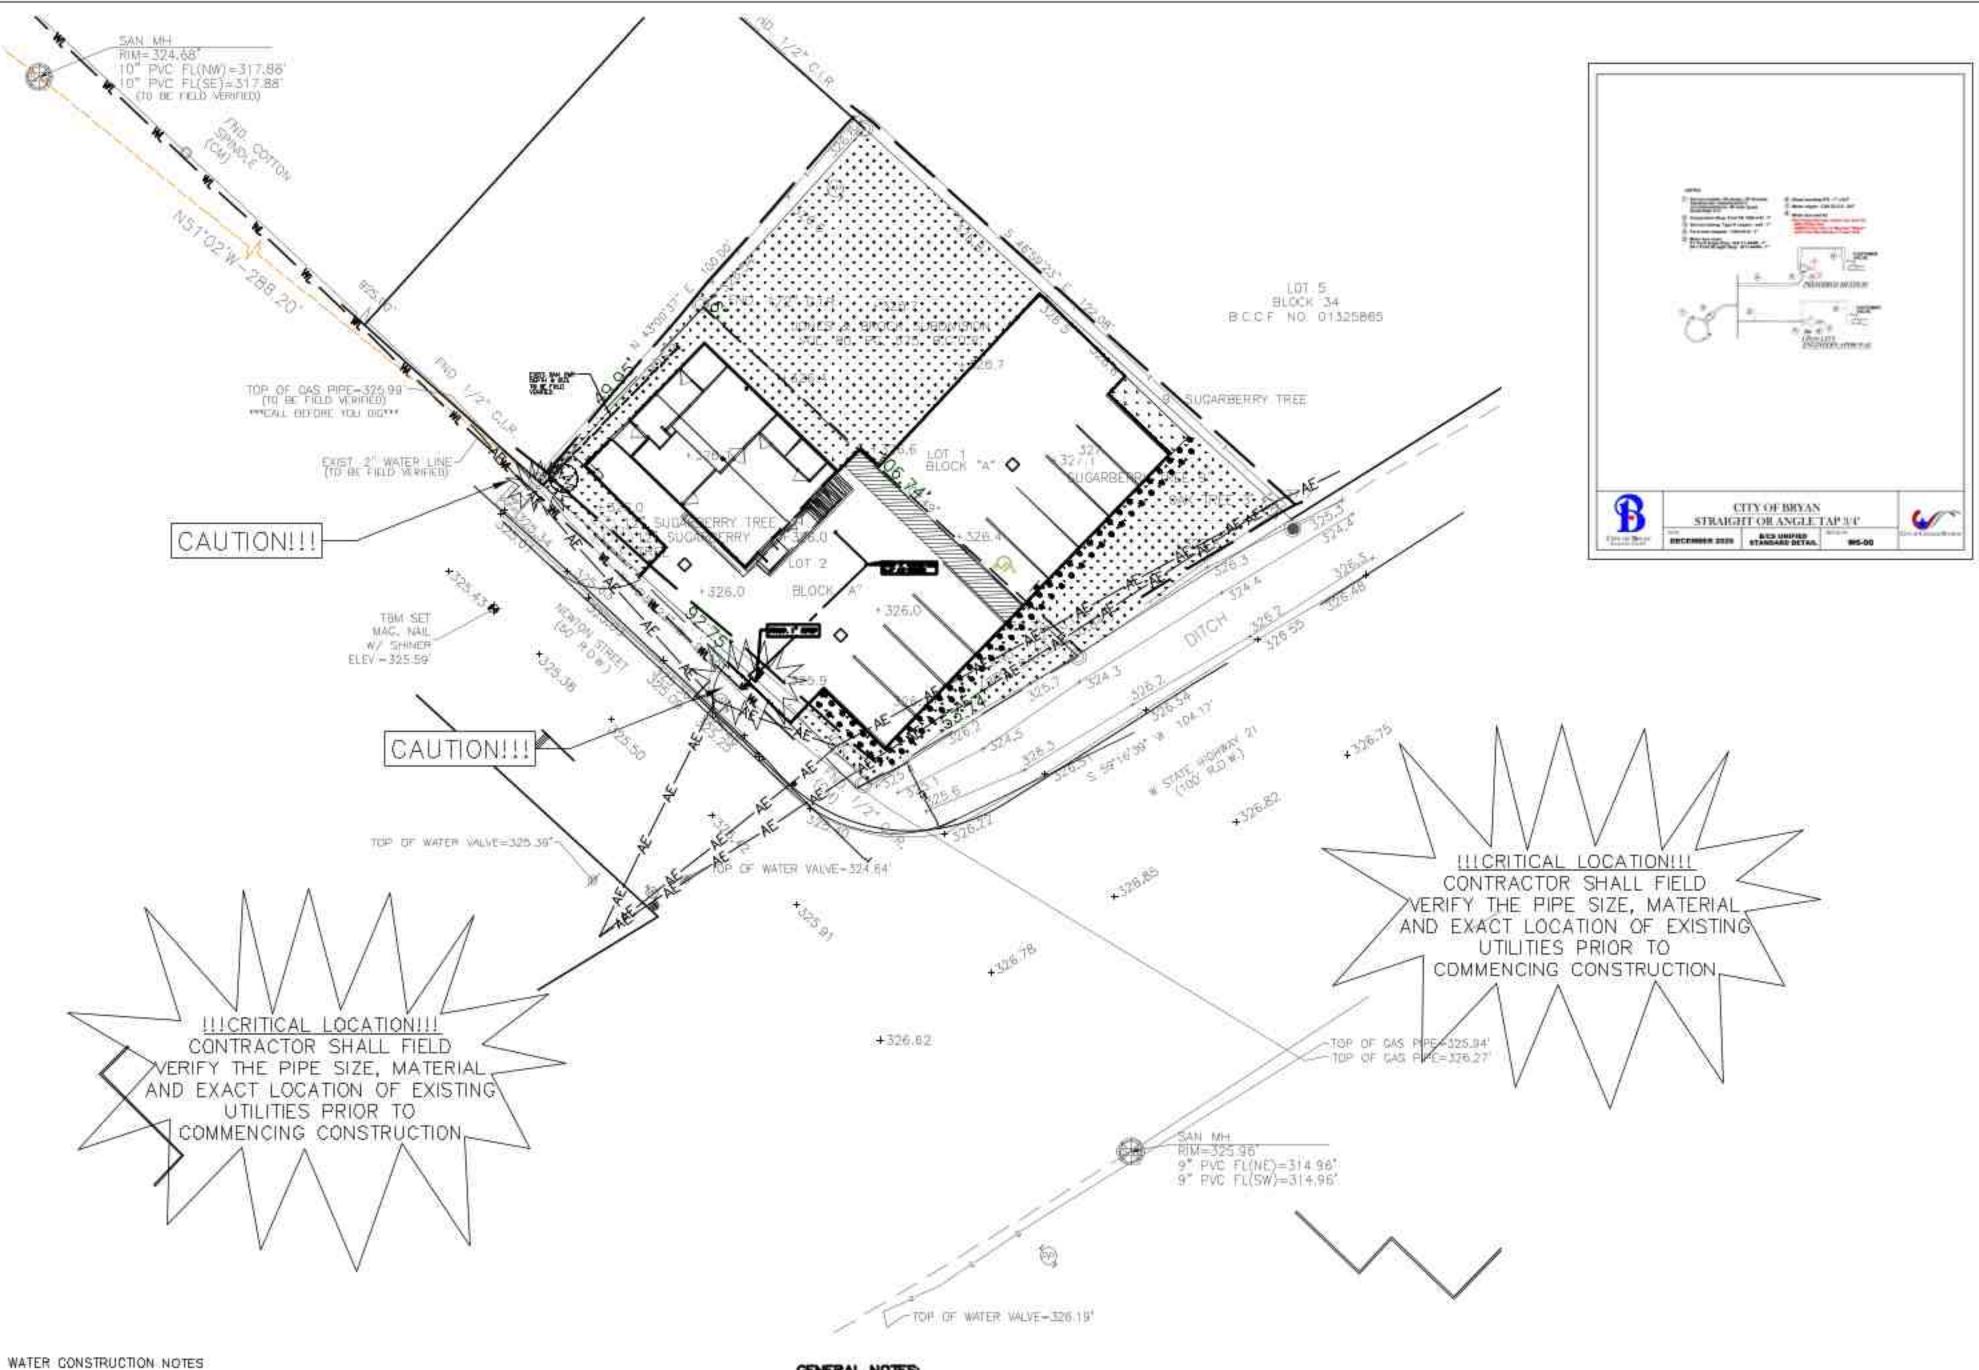



GENERAL NOTES:

- WATER LINES SHALL BE CONSTRUCTED IN ACCORDANCE WITH THE LATEST CITY OF HOUSTON INFRASTRUCTURE DESIGN MANUAL, STANDARD SPECIFICATION, AND CONSTRUCTION DETAILS. 2 ALL 4" THROUGH 12" WATER LINE TO BE AWWA C-900 PVC DR-18 BLUE PRESSURE RATED WATER MAIN WITH 2" AND SMALLER WATER SERVICE LINE TO BE CONTINUOUS TYPE K COPPER TUBING PER COH STANDARD SPECIFICATION SECTION 02503, ALL 4
- WITH INSIDE LINING WITH AWWA C104 AND DOUBLE WRAPPED WITH 8-MIL POLYETHYLENE SHEETS. CONCRETE THRUST BLOCKS SHALL BE PROVIDED AS NECESSARY TO PREVENT PIPE MOVEMENT. USE RESTRAINED JOINTS WHERE PREVENTING MOVEMENT OF 18
- 4. ALL WATER LINES UNDER PROPOSED OR FUTURE PAVING AND TO A POINT OF ONE (1) FOOT BACK OF ALL PROPOSED OR FUTURE CURBS SHALL BE ENCASED IN BANK SAND TO 12" OVER PIPE AND BACKFILLED WITH CEMENT STABILIZED SAND TO WITHIN ONE (I) FOOT OF SUBGRADE.
- 5. ALL WATER LINE AND SEWER LINE CROSSINGS SHALL BE CONSTRUCTED PER CITY OF HOUSTON AND TCEQ REGULATIONS.
- ALL WATER VALVES SHALL BE SUPPLIED AND INS TALLED IN ACCORDANCE WITH THE LATEST EDITION OF AWWA C-500 AND SHALL BE OF THE RESILIENT SEAT TYPE.
- ALL WATER LINES TO BE DISINFECTED IN CONFORMANCE WITH AWWA C-651 AND THE TEXAS STATE DEPARTMENT OF HEALTH, AT LEAST ONE BACTER/OLOGICAL SAMPLE SHALL BE COLLECTED FOR EVERY 1,000 LINEAR FEET OF WATER LINE AND SHALL BE REPEATED IF CONTMINATION PERSISTS.
- 8. ALL BELOW GRADE VALVES SHALL BE GASKETED, HUB-END GATE VALVES WITH A CAST IRON BOX, EXCEPT WHERE FLANGES ARE CALLED OUT ON THE PLANS. THRU 12" FITTINGS SHALL BE CEMENT MORTAR LINED COMPACT DUCTILE IRON PRESSURE FITTINGS PER ANSI A21,53, OR PUSH ON FITTINGS PER ANSI A21,10 PRESSURE RATED AT 250 PSIG.
- 10. HYDROSTATIC TESTING: ALL WATER PIPE SHALL BE TESTED FOR LEAKAGE IN ACCORDANCE WITH THE LATEST COUNTY STANDARD CONSTRUCTION SPECIFICATIONS. TESTS ARE TO BE PERFORMED ON THE ENTIRE FOOTAGE OF WATER PIPE LINE INCLUDED IN THE PROJECT.
- 11. ALL WATER LINES TO HAVE 4 OTHER UTILITIES AT CROSSING UNLESS OTHERWISE NOTED ON PLANS. ALL WATER LINE INSTALLED OVER DEEP SHALL UTILIZE RESTRAINED JOINT FITTINGS.
- 12 CONTRACTOR SHALL KEEP WATER PIPE BLEAN AND CAPPED (OR OTHERWISE EFFECTIVELY COVERED) OPEN PIPE ENDS TO EXCLUDE INSECTS, ANIMALS OR OTHER SOURCES OF CONTAMINATION FROM UNFINISHED PIPE LINES AT TIMES WHEN CONSTRUCTION IS NOT IN PROGRESS.

- 1. CONSTRUCT WASTEWATER COLLECTION SYSTEMS, WATER LINES, STORM DRAINAGE AND STREET PAYING IN ACCORDANCE WITH THE LATEST EDITION OF THE PUBLICATIONS STANDARD CONSTRUCTION SPECIFICATIONS FOR WASTEWATER COLLECTION SYSTEMS. WATER LINES, STORM DRAINAGE AND STREET PAYING, AND STANDARD CONSTRUCTION DETAILS FOR WASTEWATER COLLECTION SYSTEMS, WATER LINES, STORM DRAINAGE, AND STREET PAVING PUBLISHED BY HOUSTON PUBLIC WORKS.
- 2. UTILITIES PRESENTED ON THESE DRAWINGS ARE SHOWN BASED ON THE BEST AVAILABLE INFORMATION. CONTRACTOR SHALL VERIFY THE EXACT LOCATIONS IN THE FIELD PRIOR TO COMMENCING CONSTRUCTION, CONTRACTOR SHALL NOTIFY TEXAS ONE CALL AT 713-223-4567/811 OR 800-344-8377 AND LONE STAR NOTIFICATION CENTER AT 800-669-8344 AT LEAST 48 HOURS BEFORE PROCEEDING WITH ANY EXCAVATION, UTILITIES MARKED WITHIN THE PUBLIC RIGHT OF WAY OR IN EASEMENTS SHALL COMPLY WITH TAC TITLE 16, PART 1, CHAPTER 18, RULE \$18.6 AND THE AMERICAN PUBLIC WORKS ADMINISTRATION (APWA) UNIFORM COLOR CODE.
- 3. CONTRACTOR SHALL BE RESPONSIBLE FOR DAMAGES TO EXISTING WATER, WASTEWATER, STORM WATER LINES AND TRAFFIC CONTROL DEVICES, DANAGES SHALL BE REPAIRED IN ACCORDANCE WITH THE HOUSTON PUBLIC WORKS, STANDARD CONSTRUCTION SPECIFICATIONS FOR WASTEWATER COLLECTION SYSTEM, WATER LINES, STORM DRAINAGE, AND STREET PAVING AND STANDARD CONSTRUCTION DETAILS FOR WASTEWATER COLLECTION SYSTEMS, WATER LINES, STORM DRAINAGE, AND STREET PAVING, REFERENCED ABOVE, AT NO ADDITIONAL COST.
- 4. CONTRACTOR SHALL NOTIFY THE OFFICE OF THE CITY ENGINEER, CITY OF BRYAN FOR INSPECTION AT LEAST 48 HOURS PRIOR TO COMMENCING CONSTRUCTION.
- 5. ADEQUATE DRAINAGE SHALL BE MAINTAINED AT ALL TIMES DURING CONSTRUCTION AND ANY DRAINAGE DITCH OR STRUCTURE DISTURBED DURING CONSTRUCTION SHALL BE RESTORED TO EXISTING CONDITIONS OR BETTER.
- 6. CONTRACTOR SHALL TAKE NECESSARY PRECAUTIONS TO PROTECT ROOT SYSTEMS OF SHRUBS, PLANTS AND TREES ALONG THE AREA OF EXCAVATION.
- 7. CONTRACTOR SHALL COMPLY WITH LATEST EDITION OF OSHA REGULATIONS AND THE STATE OF TEXAS LAWS CONCERNING EXCAVATION.
- 8. CONTRACTOR SHALL MAINTAIN A SET OF REDLINE DRAWINGS AND RECORD AS-BUILT CONDITIONS DURING CONSTRUCTION. THESE REDUNE MARKED UP DRAWINGS WILL BE SUBMITTED TO THE DESIGN CONSULTANT WHO WILL MAKE THE CHANGES ON THE ORIGINAL TRACINGS, LABEL EACH SHEET IN THE SET AS "RECORD DRAWINGS", AND RETURN IT TO THE OFFICE OF THE CITY ENGINEER.

- 1. ALL SANITARY SEWER PIPE AND FITTINGS SHALL BE ASTM 3034 SDR 26 PVC.
- EXIST. SANITARY SEWER AND WATERLINE DEPTHS, FLOWLINE ELEVATIONS ARE TO BE FIELD VERIFIED. REFER TO GRADING PLAN FOR PROP. GRADING & DRAINAGE IMPROVEMENTS:
- 4. UTILITY LOCATION IS APPROXIMATE. UTILITIES PRESENTED ON THESE DRAWINGS ARE SHOWN BASED ON THE BEST AVAILABLE INFORMATION. CONSTRCTOR SHALL VERIFY THE EXACT LOCATION IN THE FIELD BEFORE COMMENCING CONSTRUCTION, CONTRACTOR SHALL NOTIFY TEXAS ONE CALL AT 713.223.4567/800.245.4545 AND LONE STAR ONE CALL AT 800 689 8344 AT LEAST 48 HOURS BEFORE PROCEEDING WITH ANY EXCAVATION.
- 5. THE EXISTING WATER LINE AND SANITARY SEWER LINE DEPTHS ARE APPROXIMATE THE CONTRACTOR SHALL VERIFY DEPTHS. BEFORE THE START OF CONSTRUCTION.
- 6. SEE SHEET POOT FOR SANITARY SEWER DEMAND CALCULATIONS.
- SEE SHEET POOT FOR SAMPLE WELL LOCATION AND DIAMETER OF SAMPLE WELL
- 8. SEE SHEET P.001 FOR INSTALLATION POINT FOR GREASE TRAP.

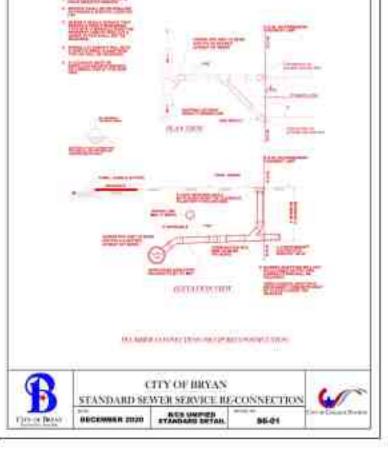

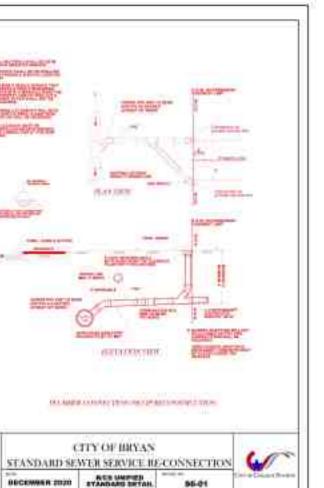

	=
12	
BENY T	_E
	<u>E</u>
	*
w Com	

ISSUE LOG PROPOSED LEGEND: WATER METER OWM ISSUE DESCRIPTION SERVICE SADDLE - WATER LINE — SANITARY SEWER LINE SAN SWR CLEANOUT STORM SEWER LINE STORM SEWER INLET RPBFP - REDUCED PRESSURE BACKFLOW PREVENTER

XISTING:

RON ROD FOUND 1/2" I.R. W/ "VILLA 8751" GAP SET POWER POLE SERVICE POLE

BUT ANCHOR SANITARY MANHOLE

WATER VALVE & BOX

FIRE HYDRANT TEMPORARY BENCHMARK

GAS VALVE CHAIN LINK FENCE

OVERHEAD ELECTRIC OHE -CENTER OF SWALE TOP OF BANK





TEXAS BOARD OF PROFESSIONAL ENGINEERS F-19379 4611 BIGGAM DRIVE FRESNO, TEXAS 77545 (832) 443-4150

PROPOSED COFFEE HOUSE 1500 NEWTON STEET BRYAN, TEXAS 77803


UTILITY PLAN


DESIGNED BY : G.W. CHECKED BY : APPROVED BY :

DATE: AUG. 15, 2023 SCALE : 1" = 20'-0" PROJECT NO :


SHEET

C8.00

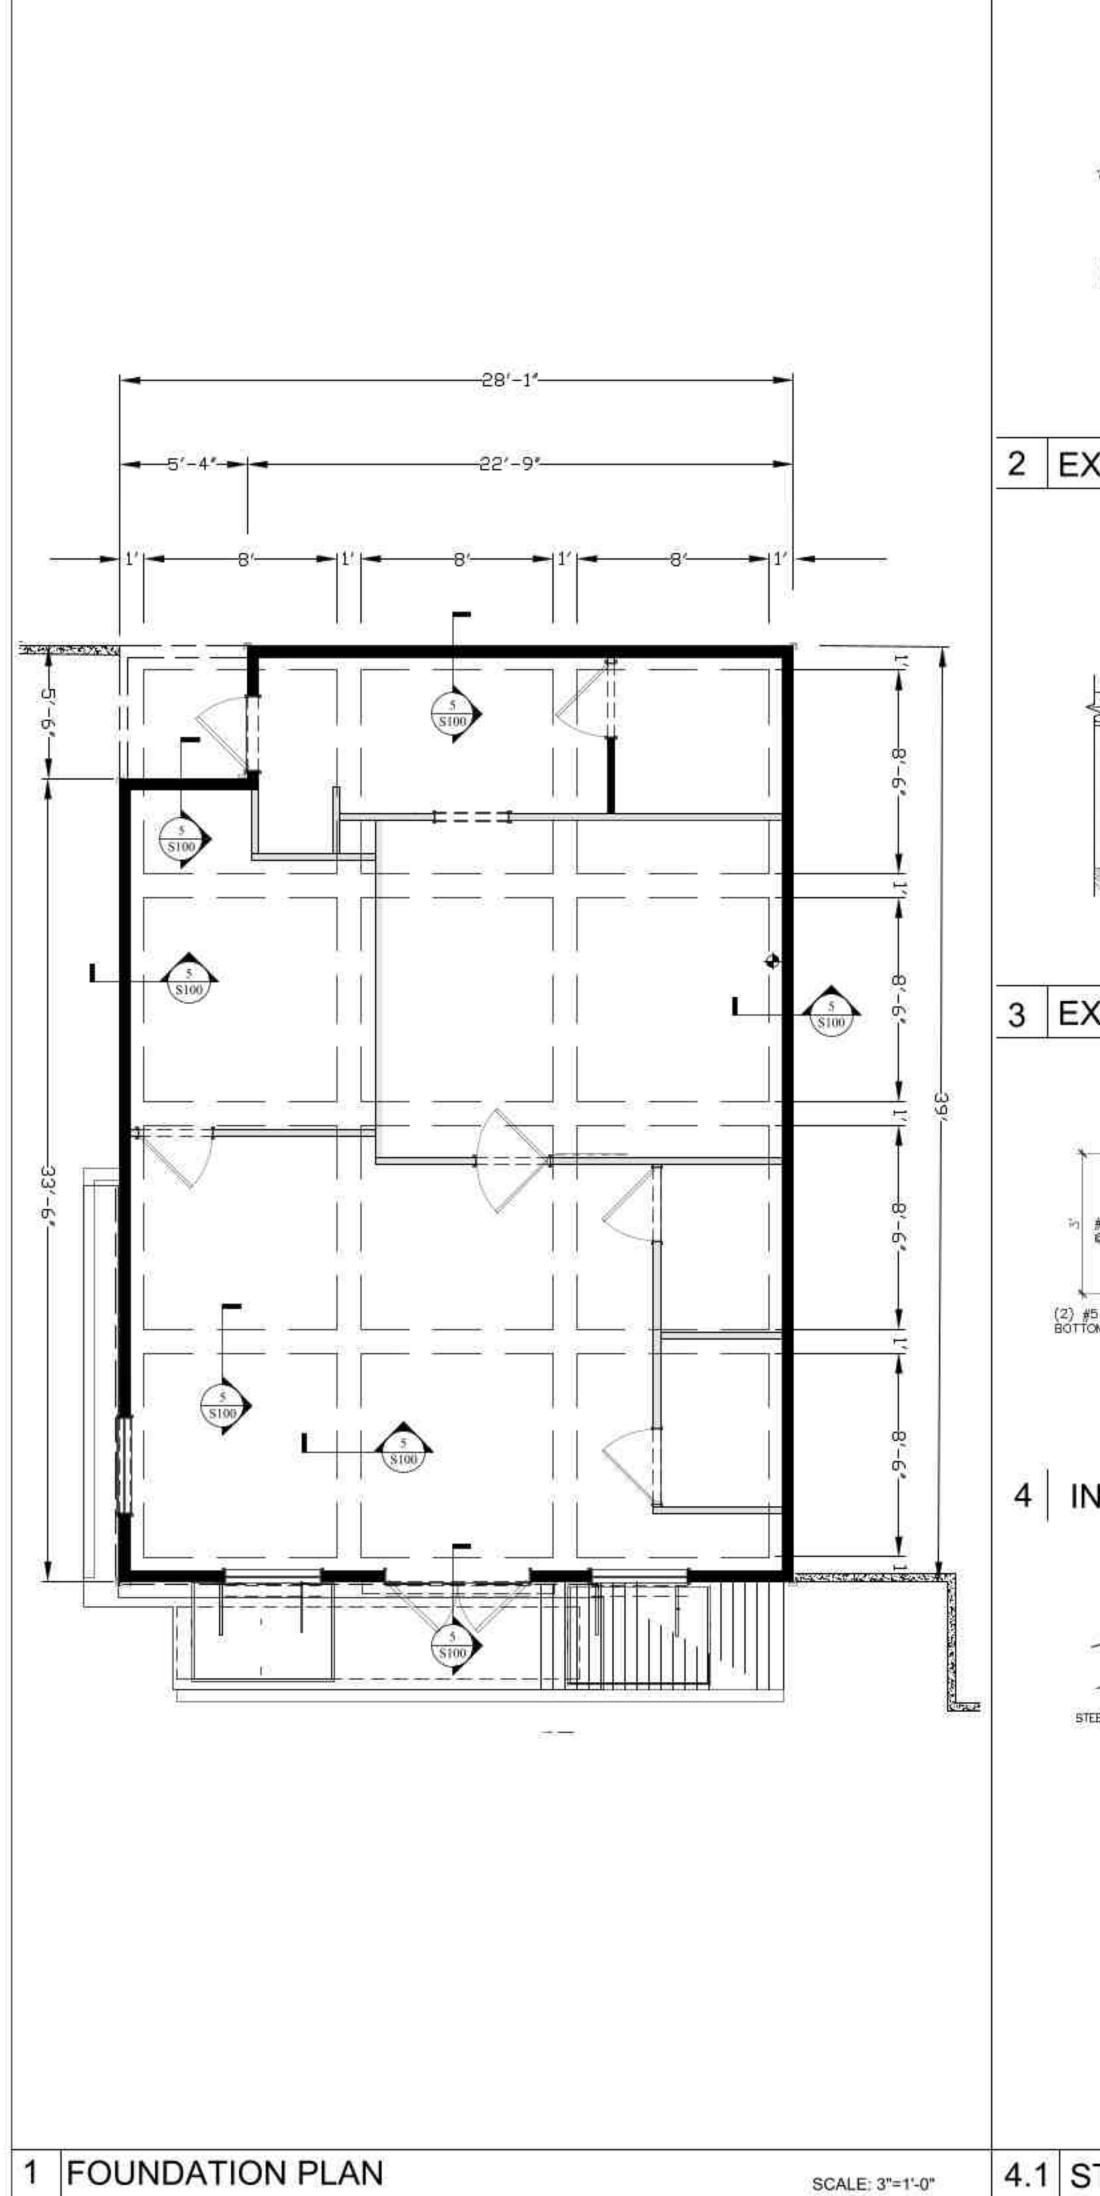


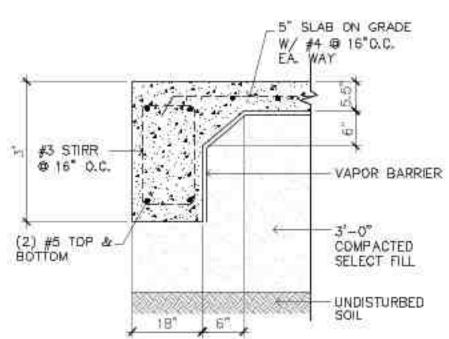


EXTERIOR BEAM DETAIL

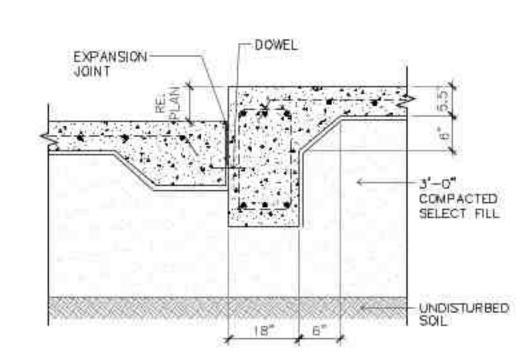

EXTERIOR BEAM DETAIL

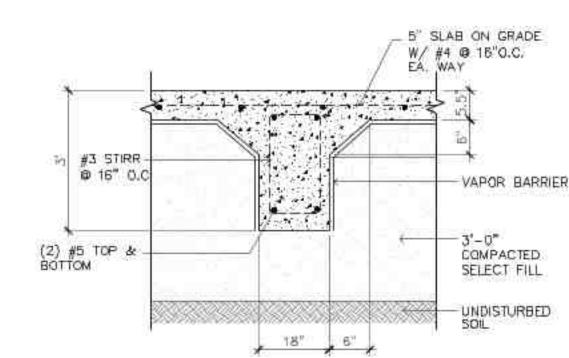

INTERIOR BEAM DETAIL

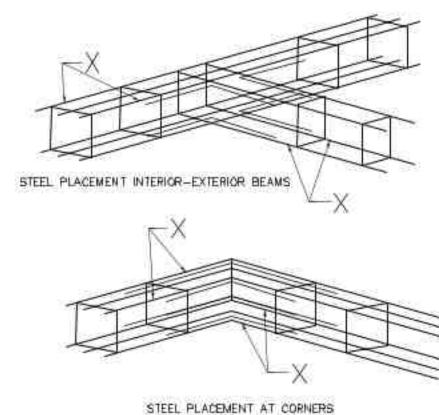

- NOTES:
 1. "X" CORNER BARS SHALL BE CONSTRUCTED AS FOLLOWS:
- EQUAL IN DIAMETER TO THE LARGEST SIZE OF ANY BARS MEETING AT ANY EXTERIOR CORNER.
- 48 INCHES MINIMUM IN LENGTH (24"X24").

FOUNDATION NOTES:

- BUILDER MUST VERIFY ALL RAISE, DROPS, INSERTS, AND BLOCKOUT AND ENSURE DIMENSIONS AGREE WITH
- ARCHITECTURAL PLANS AND SPECIFICATIONS, AN UNDERLAYMENT FOR EQUIVALENT MATERIAL SHOULD BE PLACED AT CERAMIC OR CLAY TILE AREAS TO PREVENT DIRECT BONDING OF FLOOR COVERING TO CONCRETE SLAB. A 6X6XW22.9XW2.9 WWF IS RECOMMENDED AT ALL PORCHES
- AND AT CERAMIC, BRICK OR CLAY TILE AREAS FOR CRACK CONTROL. DUE TO DIMENSIONAL DISCREPANCIES AND/OR OMISSION IN ARCHITECTURAL DRAWINGS, SOME DIMENSIONS MAY NOT AGREE WITH FLOOR PLAN. BUILDER SHALL BE RESPONSIBLE FOR FINAL VERIFICATION OF ALL SLAB DIMENSIONS. IF IT IS DETERMINED THAT ANY DIMENSIONS ON THIS FOUNDATION DO NOT CONFORM WITH THE ARCHITECTURAL PLAN, THE WECS SHOULD BE NOTIFIED AND ALLOWED TO REVIEW THE DRAWING AND MAKE REVISIONS AS REQUIRED. HOLD DOWN SIMPSON STHD14, HTTD OR HD58 OR EQUIVALENT SEE FRAMING DETAILS.

THIS PLAN IS TO BE USED ONLY FOR THE LOCATION INDICATED ON THE TITLE BLOCK.

BEAM DIMENSIONS SHOWN ARE MINIMUM REQUIRED AND MAY NOT BE REDUCED NOR ENLARGED WITHOUT APPROVAL OF

NO FIELD SUPERVISION IS PROVIDED UNDER THIS SEAL UNLESS OTHERWISE NOTED IN WRITING ON THIS PLAN. SLAB INSPECTIONS AFTER CONSTRUCTION WILL BE BILLED AT AN HOURLY RATE IF REQUESTED.

8. TOP OF SLAB ELEVATION IS FOR REFERENCE ONLY. CONTRACTOR IS TO VERIFY REQUIRED TOP OF SLAB ELEVATION. WITH SURVEYOR PRIOR TO SETTING FORMS.

6 FOUNDATION CONSTRUCTION NOTES

CONCRETE

- 1. LAPS, SPUCES, TIES, AND IMBEDMENT LENGTHS FOR REINFORCING STEEL SHALL BE IN ACCORDANCE WITH A.C.I. "MANUAL OF STANDARD PRACTICE, DETAILS, AND DETAILING OF CONCRETE REINFORCEMENT", A.C.I. 318, A.C.I. 315, AND IN ACCORDANCE WITH C.R.S.I. STANDARDS. ALL CONCRETE WORK SHALL BE IN STRICT ACCORDANCE WITH A.C.I. STANDARD SPECIFICATION FOR CONCRETE AND REINFORCED CONCRETE ALL CONCRETE PLACEMENT SHALL CONFORM TO A.C.I. 301 AND A.C.I. 318.
- COMPRESSION EMBEDMENT LENGTH SHALL BE 30 BAR DIAMETERS UNLESS NOTED OTHERWISE. 3. CLEAR DISTANCE BETWEEN ADJACENT LAYERS OF REINFORCEMENT SHALL BE 2 INCHES MINIMUM UNLESS
- 4. THE CONTRACTOR SHALL BE ALLOWED TO MAKE SPLICES IN ADDITION TO THOSE INDICATED ON THE DRAWINGS WHERE ESSENTIAL TO CONSTRUCTABILITY, SUBJECT TO ENGINEER'S APPROVAL
- 5. SUBJECT TO ENGINEER'S APPROVAL, BARS MAY BE SHIFTED SLIGHTLY IN THE FIELD WHERE NECESSARY
- TO AVOID OPENINGS, PIPES, EMBEDDED ITEMS, OR OTHER OBSTRUCTIONS. HOOKS AND BENDS SHALL BE IN ACCORDANCE WITH ACI 318.
- 7. PLACEMENT, CLEARANCES, AND MINIMUM CONCRETE COVER FOR REINFORCING SHALL BE PROVIDED IN
- ACCORDANCE WITH A.C.I. 318: SEE ARCHITECTURAL DRAWINGS FOR TOP OF SLAB ELEVATIONS, SLOPES, RECESSES, LEDGES, AND STEPS.
- 9 ALL CONCRETE IN FOUNDATION BEAMS AND SLABS SHALL HAVE A MINIMUM COMPRESSIVE STRENGTH OF 3000 P.S.I. AT 7 DAYS AT THE TIME OF STRESSING AND 3500 P.S.I. AT 28 DAYS, CONCRETE DESIGN MIX SHALL
- BE IN ACCORDANCE WITH THE A.C.I. BUILDING CODE (REQUIREMENTS A.C.I. 318-89) 10. BOTTOMS OF ALL EXCAVATIONS AND EARTHEN FORMS SHALL BE FLAT, LEVEL, TRUE TO CRADE AND LINE, AND COMPLETELY FREE OF LOOSE DIRT, DEBRIS, AND SLUSH, DAMPEN EARTH AGAINST WHICH CONCRETE IS
- POURED JUST PRIOR TO THE POUR, BUT DO NOT POUR INTO TRENCHES WITH STANDING WATER 11. FORMS FOR EXPOSED FINISH CONCRETE: PLYWOOD, METAL, METAL-FRAMED PLYWOOD FACED, OR OTHER
- ACCEPTABLE PANEL-TYPE MATERIALS TO PROVIDE CONTINUOUS, STRAIGHT, SMOOTH, EXPOSED SURFACES. 12. ALL REINFORCING STEEL SHALL BE GRADE 60 BAR CONFORMING TO THE LATEST EDITION OF ASTM.
- 13. ALL EXTERIOR BRICK AND OR MASONRY WALLS TO HAVE EXPANSION AND CONTRACTION JOINTS, REFER TO ARCHITECTURAL DETAILS FOR LOCATIONS AND INFORMATION REGARDING SPACING, TYPE, LOCATION, INSTALLATION, AND MAINTENANCE, BRICK FLASHING AREAS MUST BE EXTENDED COMPLETELY TO THE EDGE OF THE CONCRETE IN ALL DIRECTIONS TO PREVENT BONDING TO THE FOUNDATION.
- 14. SOIL PSI DESIGNED IN ACCORDANCE WITH 2015 IRC & FOR 1500 PSI LOAD BEARING PRESSURE.
- 15. REQUIRED 6 ML PLOY, VAPOR BARRIER BETWEEN GRADE BEAM & SELECT COMPACT FILL
- 15. 6" SLAB W/ #3 REBAR @ 15" D.C.E.W
- 17. ALL CONCRETE TO BE 3,500 PSI.
- CONCRETE FOR TUBE COLUMNS SHALL BE 3,500 PSI.
- CONTRACTOR SHALL ACHIEVE 95% SOIL COMPACTION.
- 20. MINIMUM OF 24" OF SELECT COMPACT FILL IS REQUIRED FOR FOUNDATION OR PADS.

CONCRETE FOUNDATION NOTES





ISSUE LOG

ISSUED:

ISSUE DESCRIPTION

TEXAS BOARD OF PROFESSIONAL ENGINEERS F-19379 4611 BIGGAM DRIVE FRESNO, TEXAS 77545 (832) 443-4150

PROPOSED COFFEE HOUSE 1500 NEWTON STEET BRYAN, TEXAS 77803

FOUNDATION PLAN


CHECKED BY APPROVED BY

DATE: AUG. 15, 2023 PROJECT NO :

SHEET

4.1 STEEL PLACEMENT

S1.00

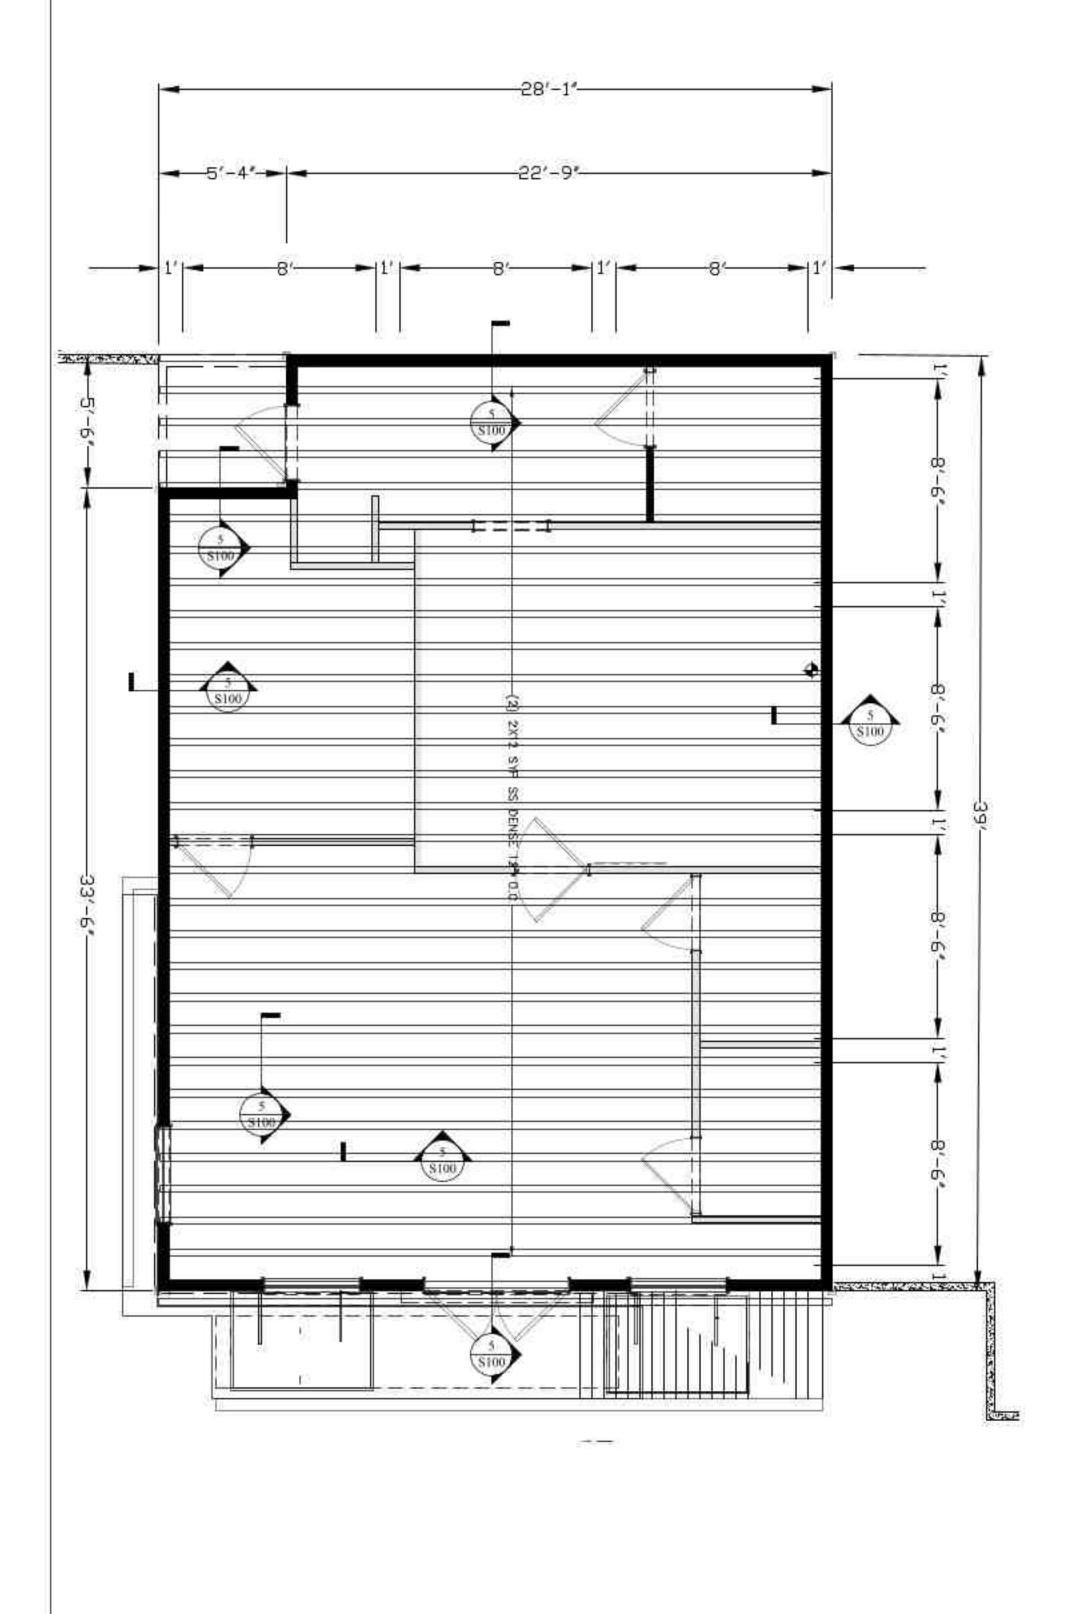

NOTES:

- 1. SEE PLAN FOR STUD SPACING IN EXCEPTION TO SCHEDULE AND FOR STUD SPACING OF NON-STANDARD HEIGHT WALLS.
- 2. REFER TO "WOOD FRAMING NOTES" SECTION OF STRUCTURAL SPECIFICATIONS FOR CONDITIONS OF USE FOR FINGER JOINTED STUDS.
- 3. REFER TO "WOOD FRAMING NOTES" SECTION OF STRUCTURAL SPECIFICATIONS FOR MATERIAL AND LUMBER GRADE USING DFL OR SYP.
- 4. NON-BEARING WALLS SHALL BE 2x4 @ 16" O.C..
- 5. SHEARWALLS SHALL BE FRAMED IN ACCORDANCE WITH SCHEDULE ABOVE. IN NO CASE SHALL STUD SPACING BE GREATER THAN 16" O.C.
- 6. ALL STUDS SHALL BE MIN. "STUD GRADE" SYP OR DFL.
- 7. AT "WET WALL" USE 2x6 STUDS, FOLLOW SAME SPACING AS SCHEDULED FOR THE CONTINUING WALL.
- 8. FOR WALL STUDS SPACED @ 8" O.C. CONTRACTOR CAN USE 1 STAGGERED STUD W/2 STUDS @ 16" O.C.

ATTACHMENT	TACHMENT ANCHOR EMBEDMENT TYPE	LOCATION AND SPACING		
		EXTERIOR WALLS	INTERIOR WALLS	
1/2"Ø ANCHOR BOLTS	7"	32" O.C.	72" O.C.	
1/2"Ø EXPANSION ANCHORS	2 1/4"	N.A.	72" O.C.	
0.177Ø POWDER-NAILS ACTUATED FORM	1 1/2"	N.A.	24" O.C.	
0.099Ø POWDER-NAILS ACTUATED FORM	1"	N.A.	12" O.C.	
M.A.S.	4"	32"	N.A.	

NOTES:

- EXPANSION ANCHORS SHALL NOT BE ALLOWED WITHIN 10 INCHES OF SLAB EDGE.
- 2. SECURE PLATE AT ANCHOR BOLTS WITH STANDARD PLATE WASHER AND NUT.

ISSUE LOG

No.	DATE ISSUED:	ISSUE DESCRIPTION
-		
	1	





TEXAS BOARD OF PROFESSIONAL ENGINEERS F-19379 4611 BIGGAM DRIVE FRESNO, TEXAS 77545 (832) 443-4150

PROPOSED COFFEE HOUSE 1500 NEWTON STEET BRYAN, TEXAS 77803

FRAMING PLAN

CHECKED BY APPROVED BY :

PROJECT NO :

SHEET

